

AERIAL MAP SCALE 1" = 400'

MINOR SUBDIVISION PRELIMINARY & FINAL SITE PLAN

BLOCK 146.02, LOT 9.02, 10.01, & 11 / BLOCK 147, LOT 1 / BLOCK 148, LOT 1 / BLOCK 149, LOT 1 & 2 / BLOCK 151, LOT 1 547 NORTH MAIN STREET TOWNSHIP OF BARNEGAT, COUNTY OF OCEAN, NEW JERSEY

3ARNEGAT BOULEVARD EXTENSION

TC-CPHD ZONE

(TOWN CENTER OVERLAY)

R-40 ZONE

(RESIDENTIAL/40,000 SF

144.02

ML-1 ZONE 34.02 (SINGLE FAMILY)_

144.01

5.02

ML-4 ZONE

(RESIDENTIAL RENTAL UNITS)

___ BLOCK NO. (TYP)

196

BAY SHORE

AVENUE

214

4-22-25

Barnegat Américan Legion Post 23 Community Options Company Barnega ISITE MAP

ZONING NOTES

2. APPLICANT:

3. LOCATION:

4. ZONE:

6. BULK SCHEDULE:

MIN. LOT AREA (SF):

MIN. LOT AREA (AC):

MIN. LOT WIDTH (FT):

MIN. LOT DEPTH (FT):

PRINCIPAL BUILDING SETBACKS:

THORN AVENUE (FT):

REAR YARD (FT):

TRASH ENCLOSURE

<u>CANOPY</u>

MIN. SIDE YARD (FT):

MIN. REAR YARD (FT):

MIN. FRONT YARD (FT):

MIN. SIDE YARD (FT):

RESTAURANT:

MAX. BUILDING HEIGHT

CANOPY (FT):

RESTAURANT (FT):

MIN. SIDE YARD (ONE) (FT):

MIN. SIDE YARDS (BOTH) (FT):

ACCESSORY BUILDING SETBACKS (TRASH):

MIN. COMBINED SIDE YARD YARD (FT):

= 10,865 S

7. BULK SCHEDULE: (TOWN CENTER OVERLAY ZONE)(CHAPTER 55, SECTION 55-34.5(D))

TOTAL REQUIRED PARKING = 115

(E) - INDICATES AN EXISTING NON-CONFORMITY

(V) - INDICATES A VARIANCE IS REQUIRED

= 5,422 SF

MAX. LOT COVERAGE BY BUILDINGS (%)

(10,865 / 122,627) = 8.86

(5,422 / 146,083) = 3.71

CONVENIENCE STORE (FT):

(9) VENDING MACHINES-PROPANE TANK EXCHANGE ETC. NOT TO OBSTRUCT ANY SW OR PED.& BIKE CIRCULATION ROUTE

(10) NO OUTDOOR STORAGE IS

AUTOMOTIVE SERVICE STATION:

5 SP/BAY (MIN. 5) =

CONVENIENCE STORE:

PERMITTED WITHIN THE FRONT

1 SP/100 GSF = (1 SP/100) X 5,585 SF =

1 SP/100 GSF = (1 SP/100) X 5,422 SF =

9. THERE WILL BE CROSS ACCESS AND PARKING EASEMENTS PROVIDED.

10.SEE SHEET C2.10. "SIGNAGE PLAN" FOR SIGN REQUIREMENTS

NC - NO CHANGE

NA - NOT APPLICABLE

<u>LEGEND</u>

(12) MAX. IMPERVIOUS COVERAGE (%):

CONVENIENCE STORE: = 5,585 SF

NORTH BARNEGAT BLVD (FT):

M&T AT 547 MAIN, LLC 547 NORTH MAIN STREET BARNEGAT, NEW JERSEY 08005

1260 STELTON ROAD PISCATAWAY, NEW JERSEY 08854

BLOCK 146.02, LOTS 9.02, 10.01, 11 / BLOCK 147, LOT 1

TC-CPHD - COMMERCIAL PLANNED HIGHWAY DEVELOPMENT

- TOWN CENTER OVERLAY ZONE

LOT 10.02 AUTOMOTIVE FUELING STATION (PERMITTED)

BLOCK 148, LOT 1 / BLOCK 149, LOT 1 & 2 / BLOCK 151, LOT 1

(PERMITTED)

(PERMITTED)

(PERMITTED)

(PERMITTED)

PROPOSED

LOT 10.02

122,627.41

2.8

208.42 (BLDG)

N/A

61.75

64.0

292.4

57.75

8.86

25.17

LOT 10.02 COMPLIES

COMPLIES

TOTAL PROVIDED PARKING = 149 (+12 SPACES

53.5

33.3 PEAK 22.5 PARAPET

85.38 (CANOPY)

45.36 (BLDG)

231.75

653.22

LOT 1.01

146,083.26

3.3

147.06

630.18

N/A

10.41 (E)

64.97

111.25

302.9

N/A

3.71

1/<35

BARNEGAT, OCEAN COUNTY, NEW JERSEY 08005

(732) 985-1900

547 NORTH MAIN STREET

EXISTING: RESTAURANT

LOT 1.01 RESTAURANT

TAX MAP SHEETS 101 & 102

VACANT LAND

CONVENIENCE STORE

CALISTO J. BERTIN, P.E. PROFESSIONAL ENGINEER MA LIC. NO. 40595 NY LIC. NO. 6002 NH LIC. NO. 9368 RI LIC. NO. 66

SHAN-PEI FANCHIANG, P.E PROFESSIONAL ENGINEER NJ LIC. NO. 37073

NY LIC. NO. 071209

COVER SHEET

WaWa Food Market & Fueling Station

BLOCK 146.02, LOTS 9.02, 10.01 & 11, BLOCK 147, LO BLOCK 148, LOT 1, BLOCK 149, LOTS 1 & 2, BLOCK 151, LOT 547 NORTH MAIN STREET TWSP OF BARNEGAT, OCEAN COUNTY, N

M&T AT 547 MAIN LLC C/O EDGEWOOD PROPERTIES, INC 1260 STELTON ROAD

PISCATAWAY, NJ 08854

24GA28068900 / 21MH00002800 C.J.B. AS SHOWN 21-312 11-8-22

MUNICIPALITIES & UTILITIES PROPERTY OWNERS WITHIN 200'

PROPERTY LOCATION ATLANTIC HEIGHTS LLC % SLK GLOBAL SOL 900 BARNEGAT BOULEVARD N 101 CHASE AVENUE JERSER CENTRAL POWER & LIGHT % FIRST ENERGY TUCKERTON RAILROAD 144.02 36.01 JERSER CENTRAL POWER & LIGHT % FIRST ENERGY TUCKERTON RAILROAD OAKBROOK, NJ 60522-4747 950 BARNEGAT BOULEVARD N P.O. BOX 2191 FINANACE DEPARTMENT TOMS RIVER, NJ 08753 OLD RR ROW TOMS RIVER, NJ 08753 OCEAN COUNTY OLD RR ROW TOMS RIVER, NJ 08753 OCEAN COUNTY 557 NORTH MAIN STREET

101 HOOPER AVENUE TOMS RIVER, NJ 08753 538 NORTH MAIN STREET

> BARNEGAT, NJ 08005 ATLAS PROPERTRY MANAGEMENT SERVICES BARNEGAT, NJ 08005

ATLAS PROPERTY MANAGEMENT SERVICES BARNEGAT, NJ 08005

24 W THORN AVENUE

409 TWIN LAKE BOULEVARD LITTLE EGG HARBOR, NJ 08087 NUCCIO, RICHARD & SORRENTINO, ZOE 23 TWAIN AVENUE

BARNEGAT, NJ 08005 VALLEY SPORTSWEAR INC 75 ROUTE 59

TRYBUN, MICHAEL 26 THORN AVENUE BARNEGAT, NJ 08005

APPROVED BY THE

ATTESTED TO BY

COUNTY PLANNING BOARD

COUNTY OF OCEAN, NEW JERSEY

DATE

BARNEGAT TOWNSHIP 900 WEST BAY AVENUE BARNEGAT, NJ 08005

380 WELLINGTON STREET 10B

538 NORTH MAIN STREET

533 NORTH MAIN STREET

529 NORTH MAIN STREET

24 THORN AVENUE

25 TWAIN AVENUE

25 TWAIN AVENUE

28 THORN AVENUE

26 THORN AVENUE

537 NORTH MAIN STREET

560 NORTH MAIN STREET

24 THORN AVENUE

21 LUKE AVENUE

BARNEGAT WATER & SEWER 900 WEST BAY AVENUE BARNEGAT NJ 08005

830 ROUTE 37 WEST TOMS RIVER NJ 08755

WEST CREEK NJ 08092

GPU ENERGY (FORMERLY JCP&L) P.O. BOX 16001 REAL ESTATE DEPT

CONECTIV (FORMERL ATLANTIC ELEC.) REAL ESTATE DEPARTMENT

540 BROAD ST ROOM 305

NJ NATURAL GAS CO 1415 WYCKOFF ROAD

WARETOWM NJ 08758

P.O. BOX 1464 WALL NJ 07719 OCEAN COUNTY UTILITIES AUTHORITY

501-HICKORY LANE P.O. BOX P

BAYVILLE NJ 08721

NJ TURNPIKE AUTHORITY (GS PARKWAY) P.O. BOX 5042 581 MAIN STREET WOODBRIDGE NJ 07095-5042

STATE OF NEW JERSEY DOT TRENTON NJ 08625 OCEAN COUNTY DOT P.O. BOX 2191

TOMS RIVER NJ 08754 NAUTILUS DRIVE WARREN GROVE ROAD

547 NORTH MAIN STREET

BAY AVENUE & BAYSHORE DRIVE
GUNNIING RIVER RD-RT 9 TO W BAY AVE
BARNEGAT BOULEVARD BROOKVILLE ROAD LIGHTHOUSE DRIVE

			DIVAMII	10	, LIJ1			
DWG. #	DRAWING TITLE	DATED/ LAST REVISED	REV. #		DWG. #	DRAWING TITLE	DATED/ LAST REVISED	REV.
C1.1	COVER SHEET	6-11-25	15		C2.10	SIGNAGE PLAN	4-22-25	8
C2.1	EXISTING CONDITIONS & DEMOLITION PLAN	4-22-25	7		C2.11	NJDEP LAND USE PLAN	4-22-25	5
C2.2	SITE PLAN	4-22-25	9		C3.1	SITE DETAILS - 1	4-22-25	6
C2.3	GRADING & SOIL EROSION SEDIMENT CONTROL PLAN	6-11-25	14		C3.2	SITE DETAILS - 2	4-22-25	5
C2.3A	SOIL EROSION & SEDIMENT CONTROL PLAN	4-22-25	3		C3.3A	DRAINAGE & SESC DETAILS	6-11-25	11
C2.3B	SOIL COMPACTION PLAN	6-11-25	3		C3.3B	DRAINAGE & SESC DETAILS 2	4-22-25	5
C2.4	UTILITY & STORMWATER MANAGEMENT PLAN	6-11-25	12		C3.4	UTILITY DETAILS	4-22-25	5
C2.5	LANDSCAPE & SIGHT TRIANGLE PLAN	6-11-25	8		C3.5	CANOPY & LIGHTING DETAILS	4-22-25	5
C2.6	LIGHTING PLAN	4-22-25	6		C3.6	STRIPING, BOLLARD PLACEMENT, CONTROL JOINT PLAN & DETAILS	4-22-25	5
C2.7	LIGHTING INTENSITIES PLAN	4-22-25	6		C3.7	LANDSCAPE & SESC DETAILS	6-11-25	11
C2.8A	VEHICLE CIRCULATION PLAN - 1	4-22-25	6		C3.8	SOIL EROSION & SEDIMENT CONTROL DETAILS	6-11-25	4
C2.8B	VEHICLE CIRCULATION PLAN - 2	4-22-25	0		C3.9	SOIL EROSION & SEDIMENT CONTROL DETAILS 2	6-11-25	3

C4.1 WATER MAIN EXTENSION PLAN

* REQUIRED ELECTRIC VEHICLE SUPPLY EQUIPMENT SPACES (EVSE):

TOTAL ADJUSTED SPACES = 153

NON-RESIDENTIAL <u>PROVIDED</u> MIN. (EVSE): (101 SP TO 150 SP) = 4MIN. HANDICAP (EVSE)(5% OF EVSE SP): $(4 \text{ SP } \times .05) = 0.2$ COMPLIES TOTAL EVSE SPACES = TOTAL SPACES PROVIDED = 149 EVSE BONUS/CREDIT (2 TO 1)(MAX. 10% OF REQUIRED) =

C2.9 MINOR SUBDIVISION & LEASE PLAN

	PHYSICAL ADDRESS	BARNEGAT, NJ 08005
	WAWA STORE NO.:	C-04289
	BUILDING TYPE	W50FB
APPROVED BY THE TOWNSHIP OF BARNEGAT	CANOPY TYPE	SLOPED
PLANNING BOARD AT A MEETING HELD ON	CANOPY CONFIGURATION	STAKED=6
2024	NO. OF MPD'S	6
	TYPE OF MPD'S	4+1
CHAIRPERSON DATE	NO. OF PARKING SPACES	50
	NO. OF HANDICAP PARKING SPACES	2
SECRETARY DATE	NO. OF TRUCK/OVERSIZE PARKING SPACES	0
	SQ. FT. OF ASPHALT (INSIDE R.O.W.)	37,315

CONTACT INFO:

WAWA INC.


260 W. BALTIMORE PIKE WAWA PA. 19063


PHYSICAL ADDRESS


WAWA STORE NO.:	C-04289
BUILDING TYPE	W50FB
CANOPY TYPE	SLOPED
CANOPY CONFIGURATION	STAKED=6
NO. OF MPD'S	6
TYPE OF MPD'S	4+1
NO. OF PARKING SPACES	50
NO. OF HANDICAP PARKING SPACES	2
NO. OF TRUCK/OVERSIZE PARKING SPACES	0
SQ. FT. OF ASPHALT (INSIDE R.O.W.)	37,315
SQ. FT. OF LAWN AREA (TO BE MOWED)	13,163
SQ. FT. OF MULCH AREA	9,608

WAWA SITE DATA TABLE

1.01 TWAIN AVENUE 15.01 152 R-MF ZONE 13 | 12 | 11 AVENUE 2 2.01 212 154 155 SCALE: 1"= 200 200' RADIUS MAP STREET NAMES TAKEN FROM TAX MAP #101, DATED 3-16-05, LAST REVISED 11-28-17 DRAWING LIST

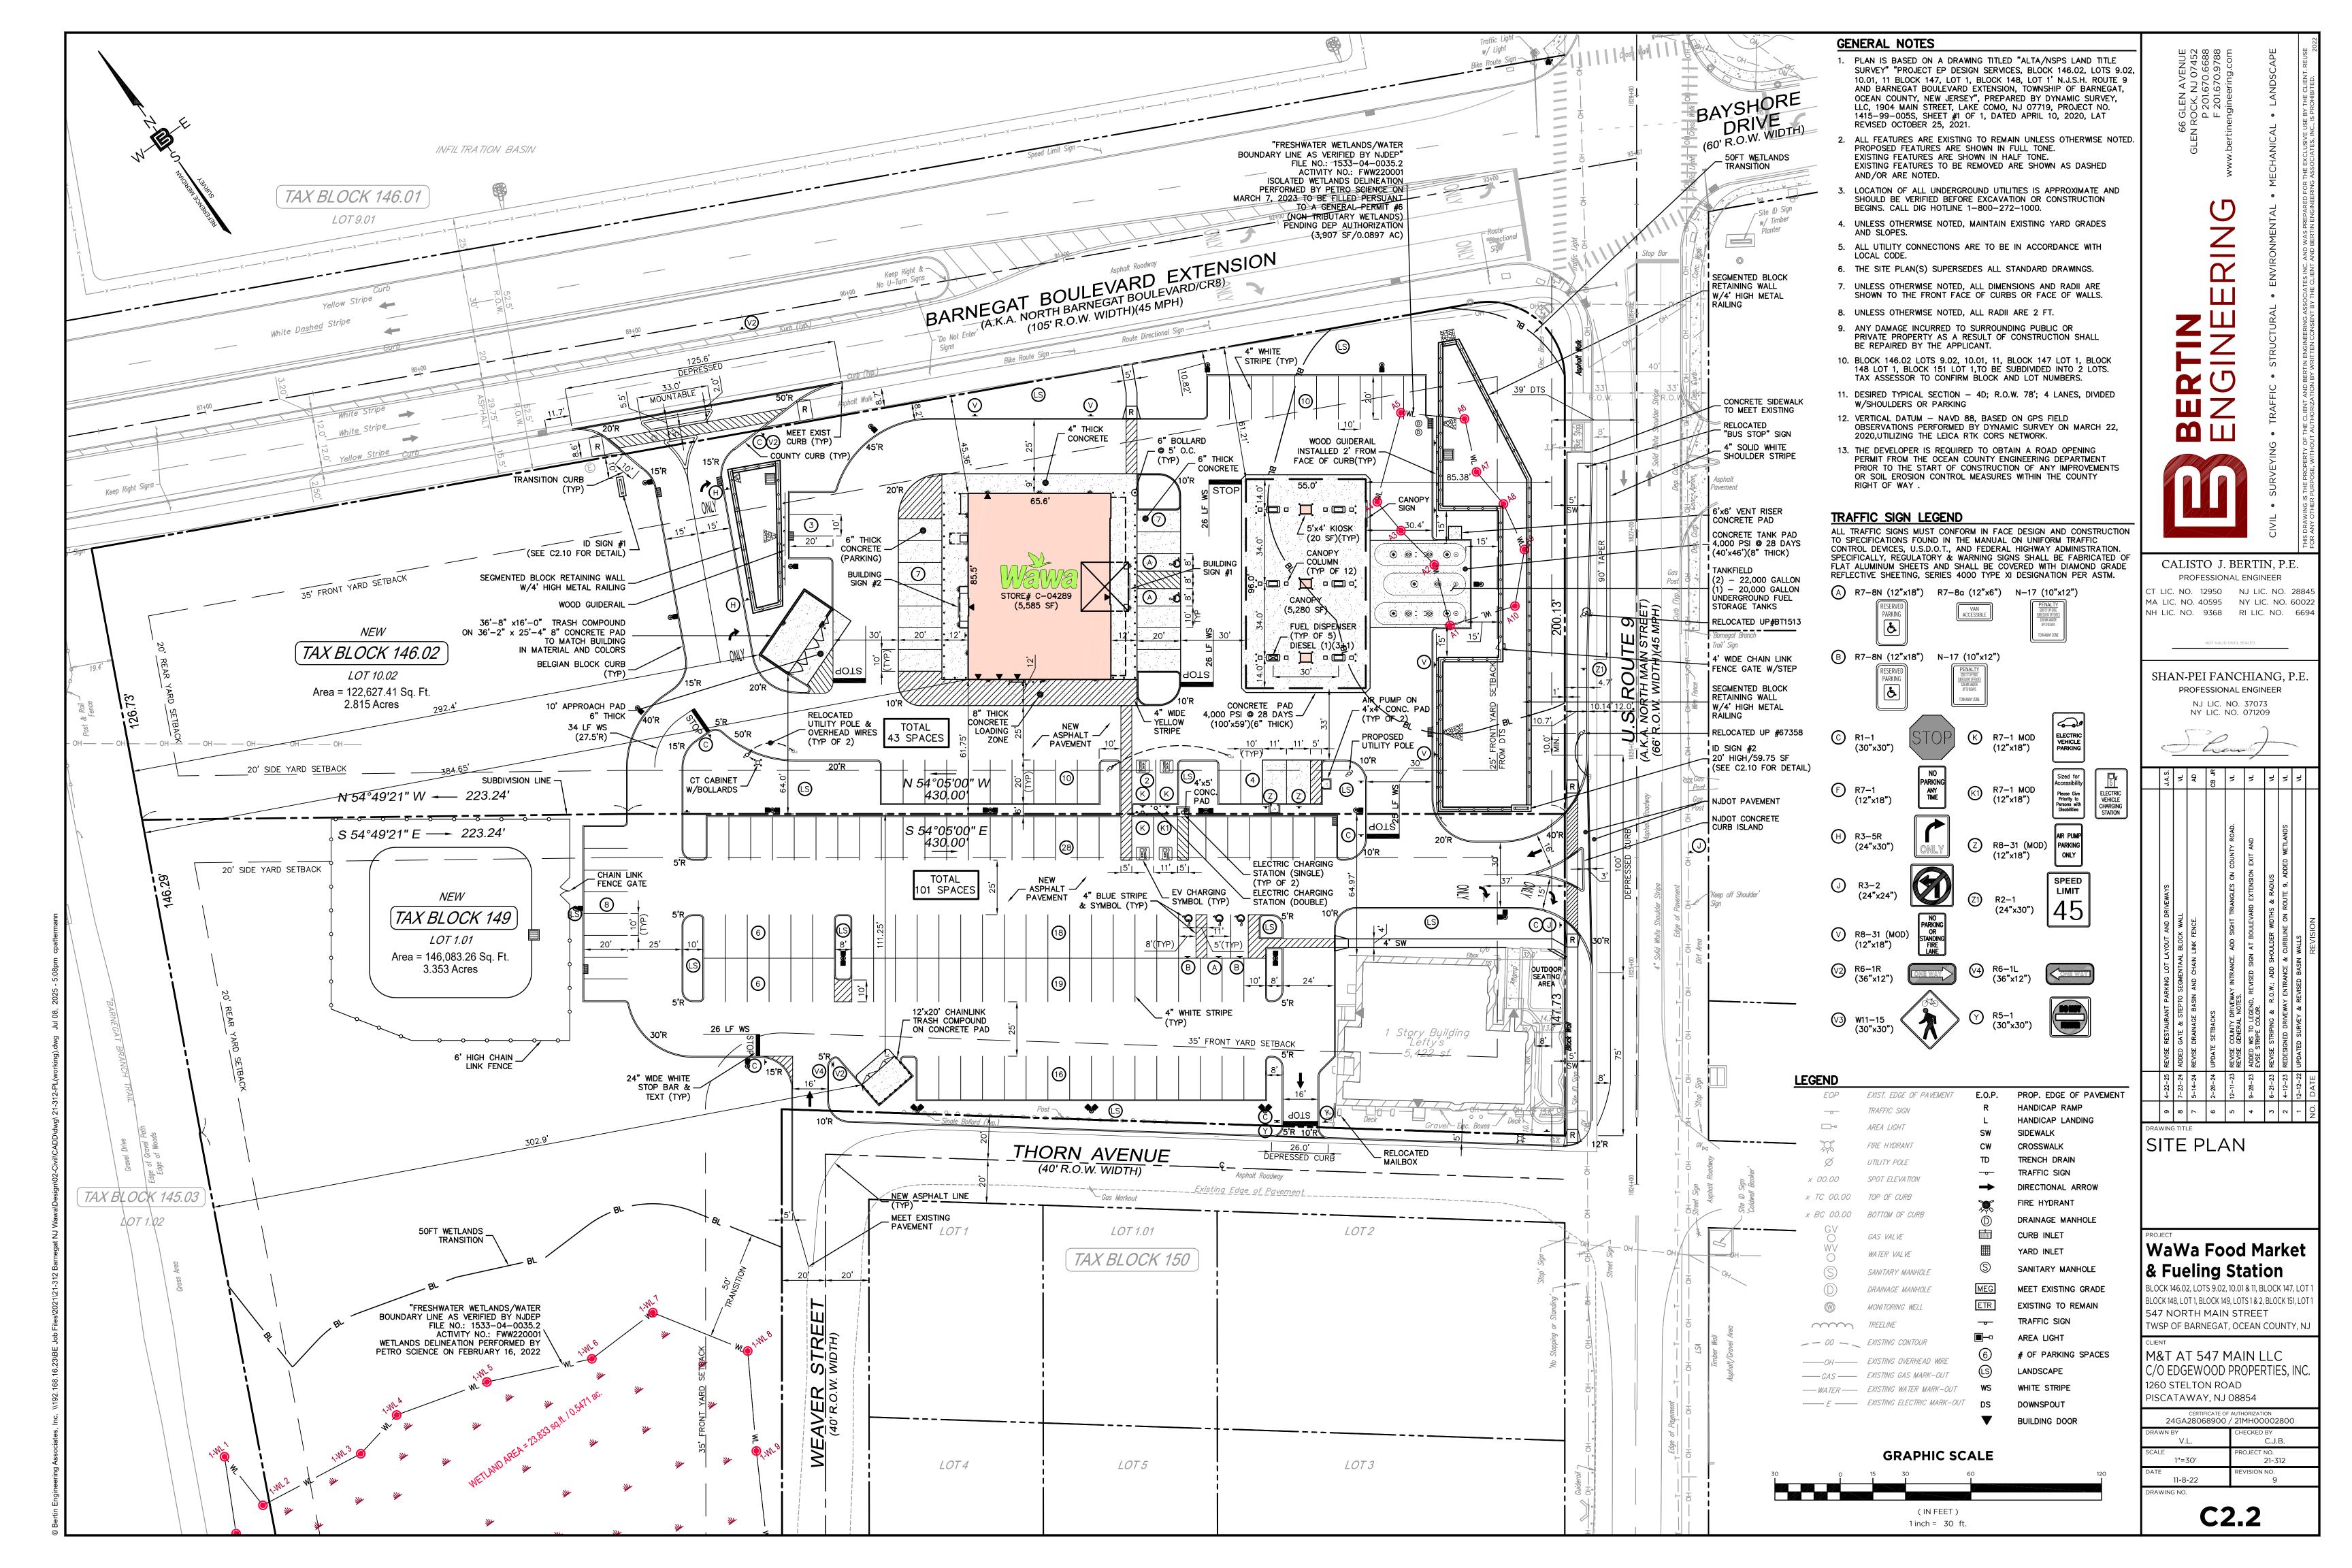

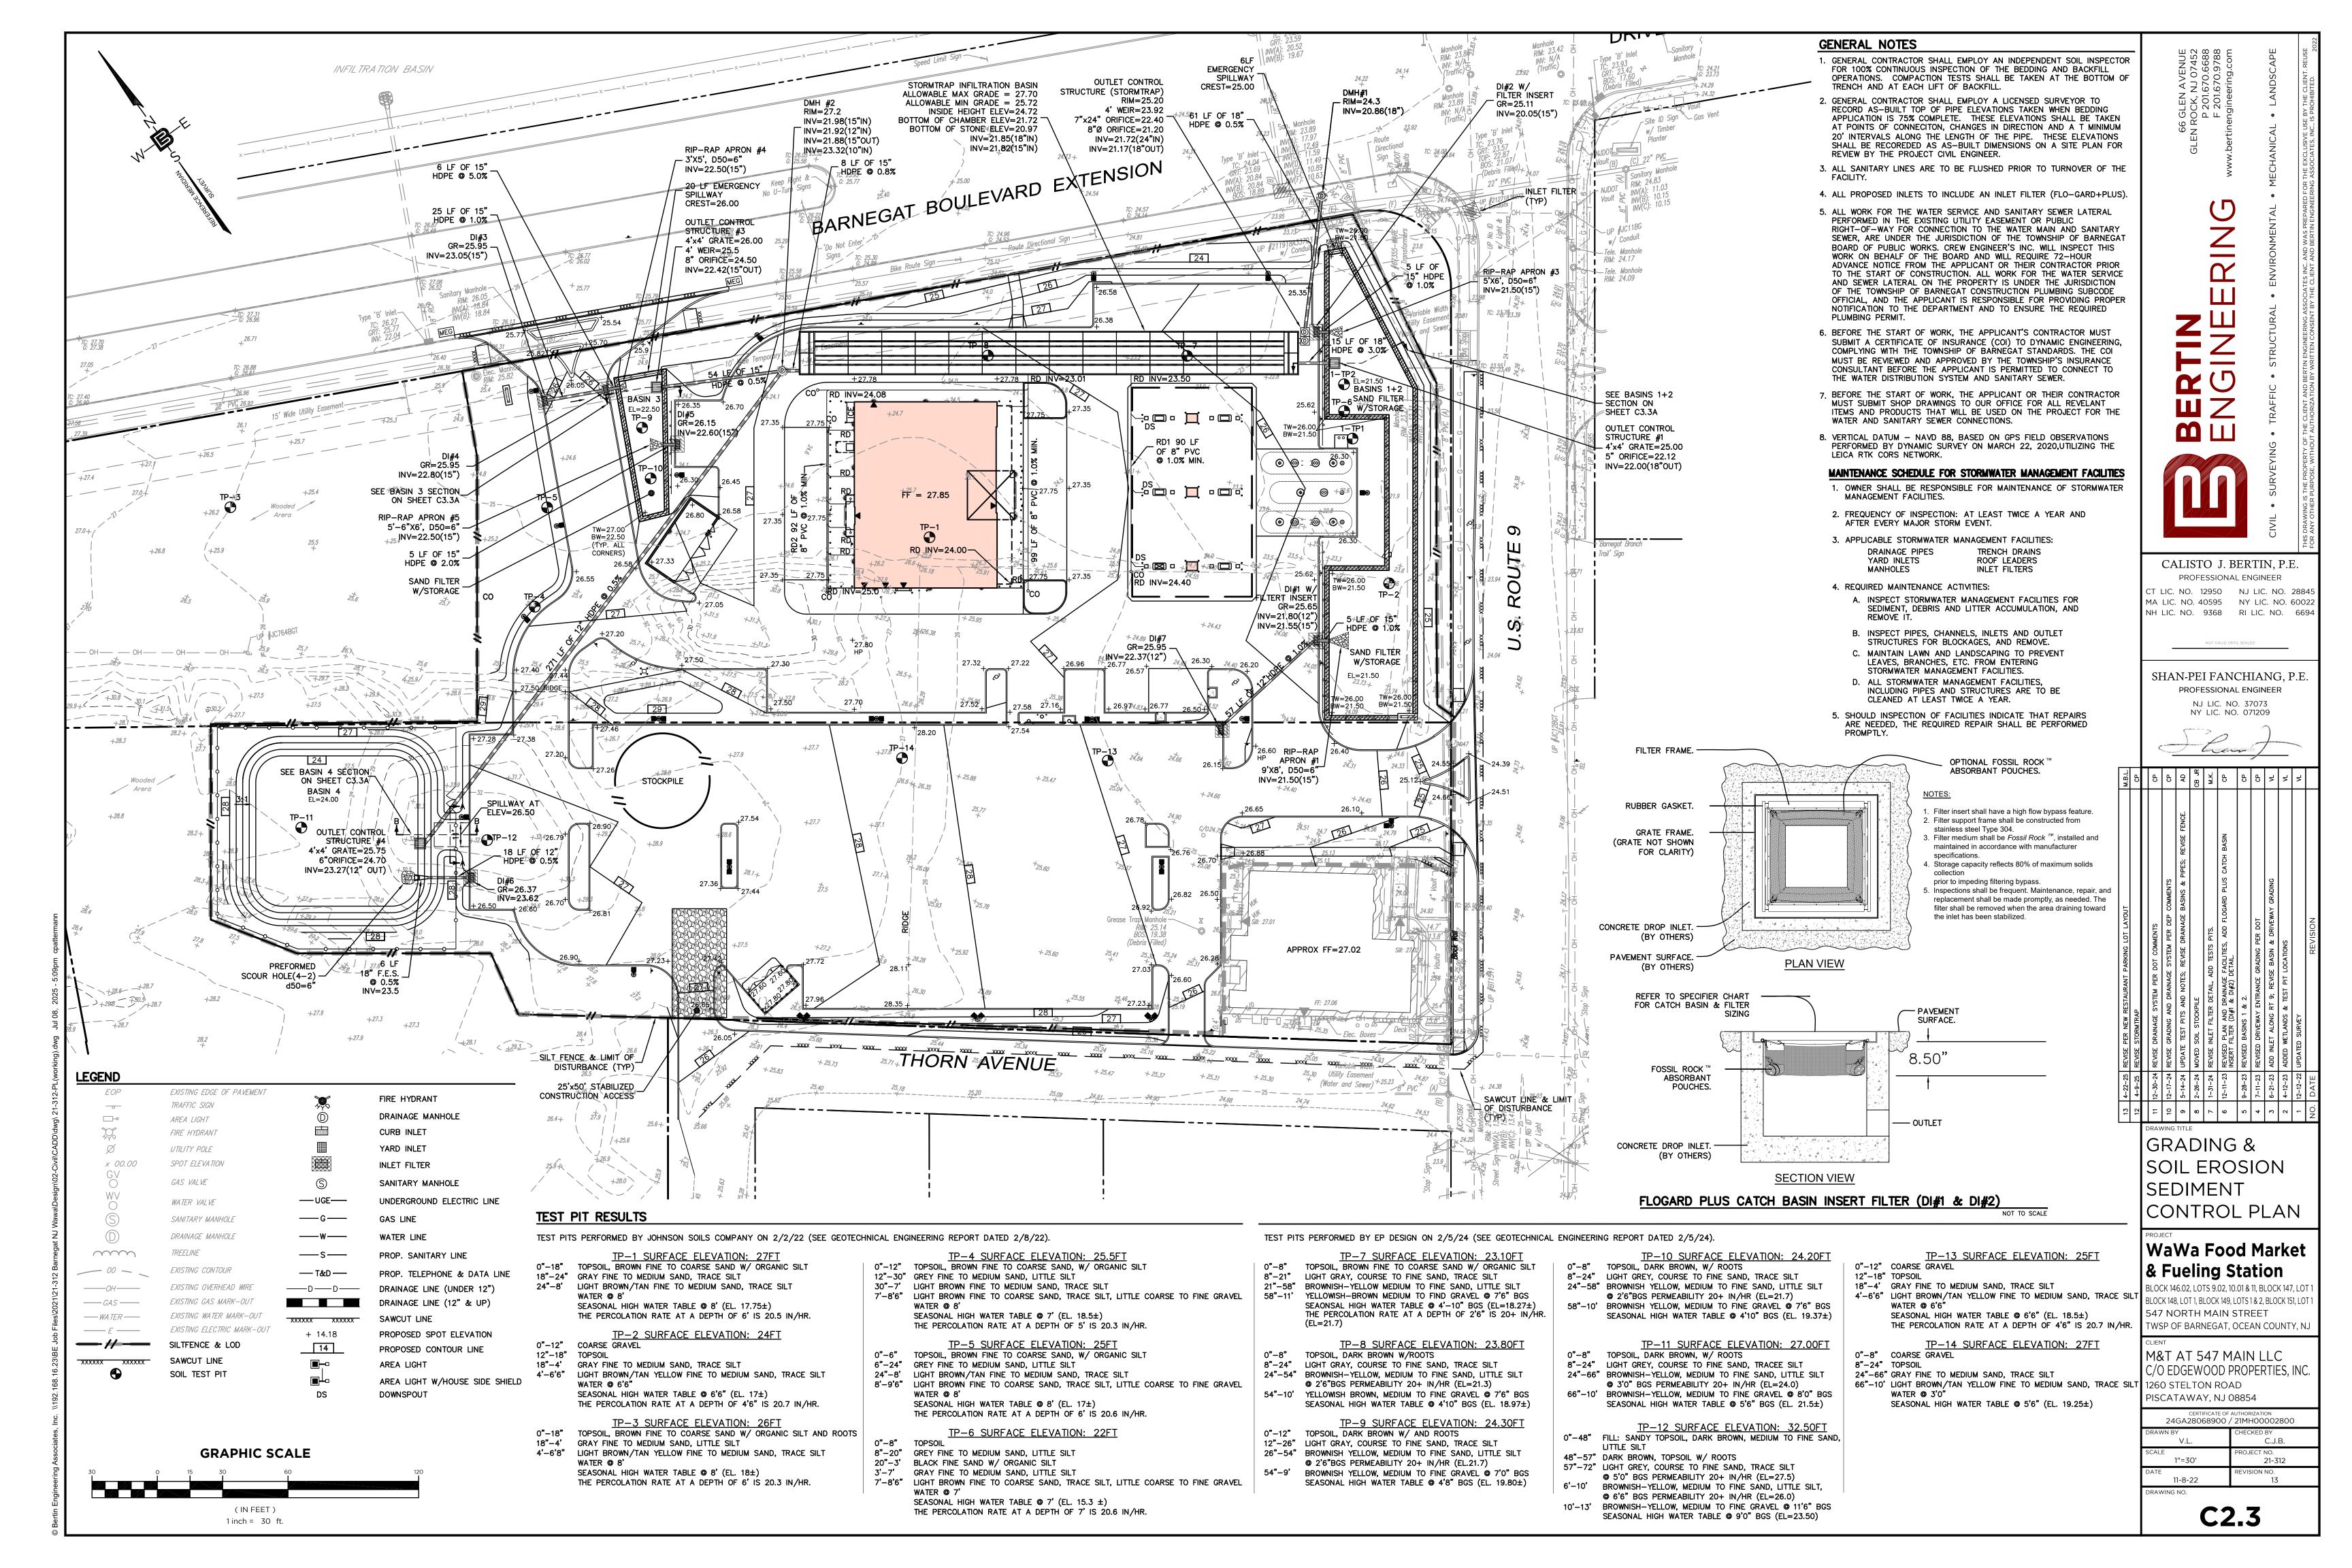

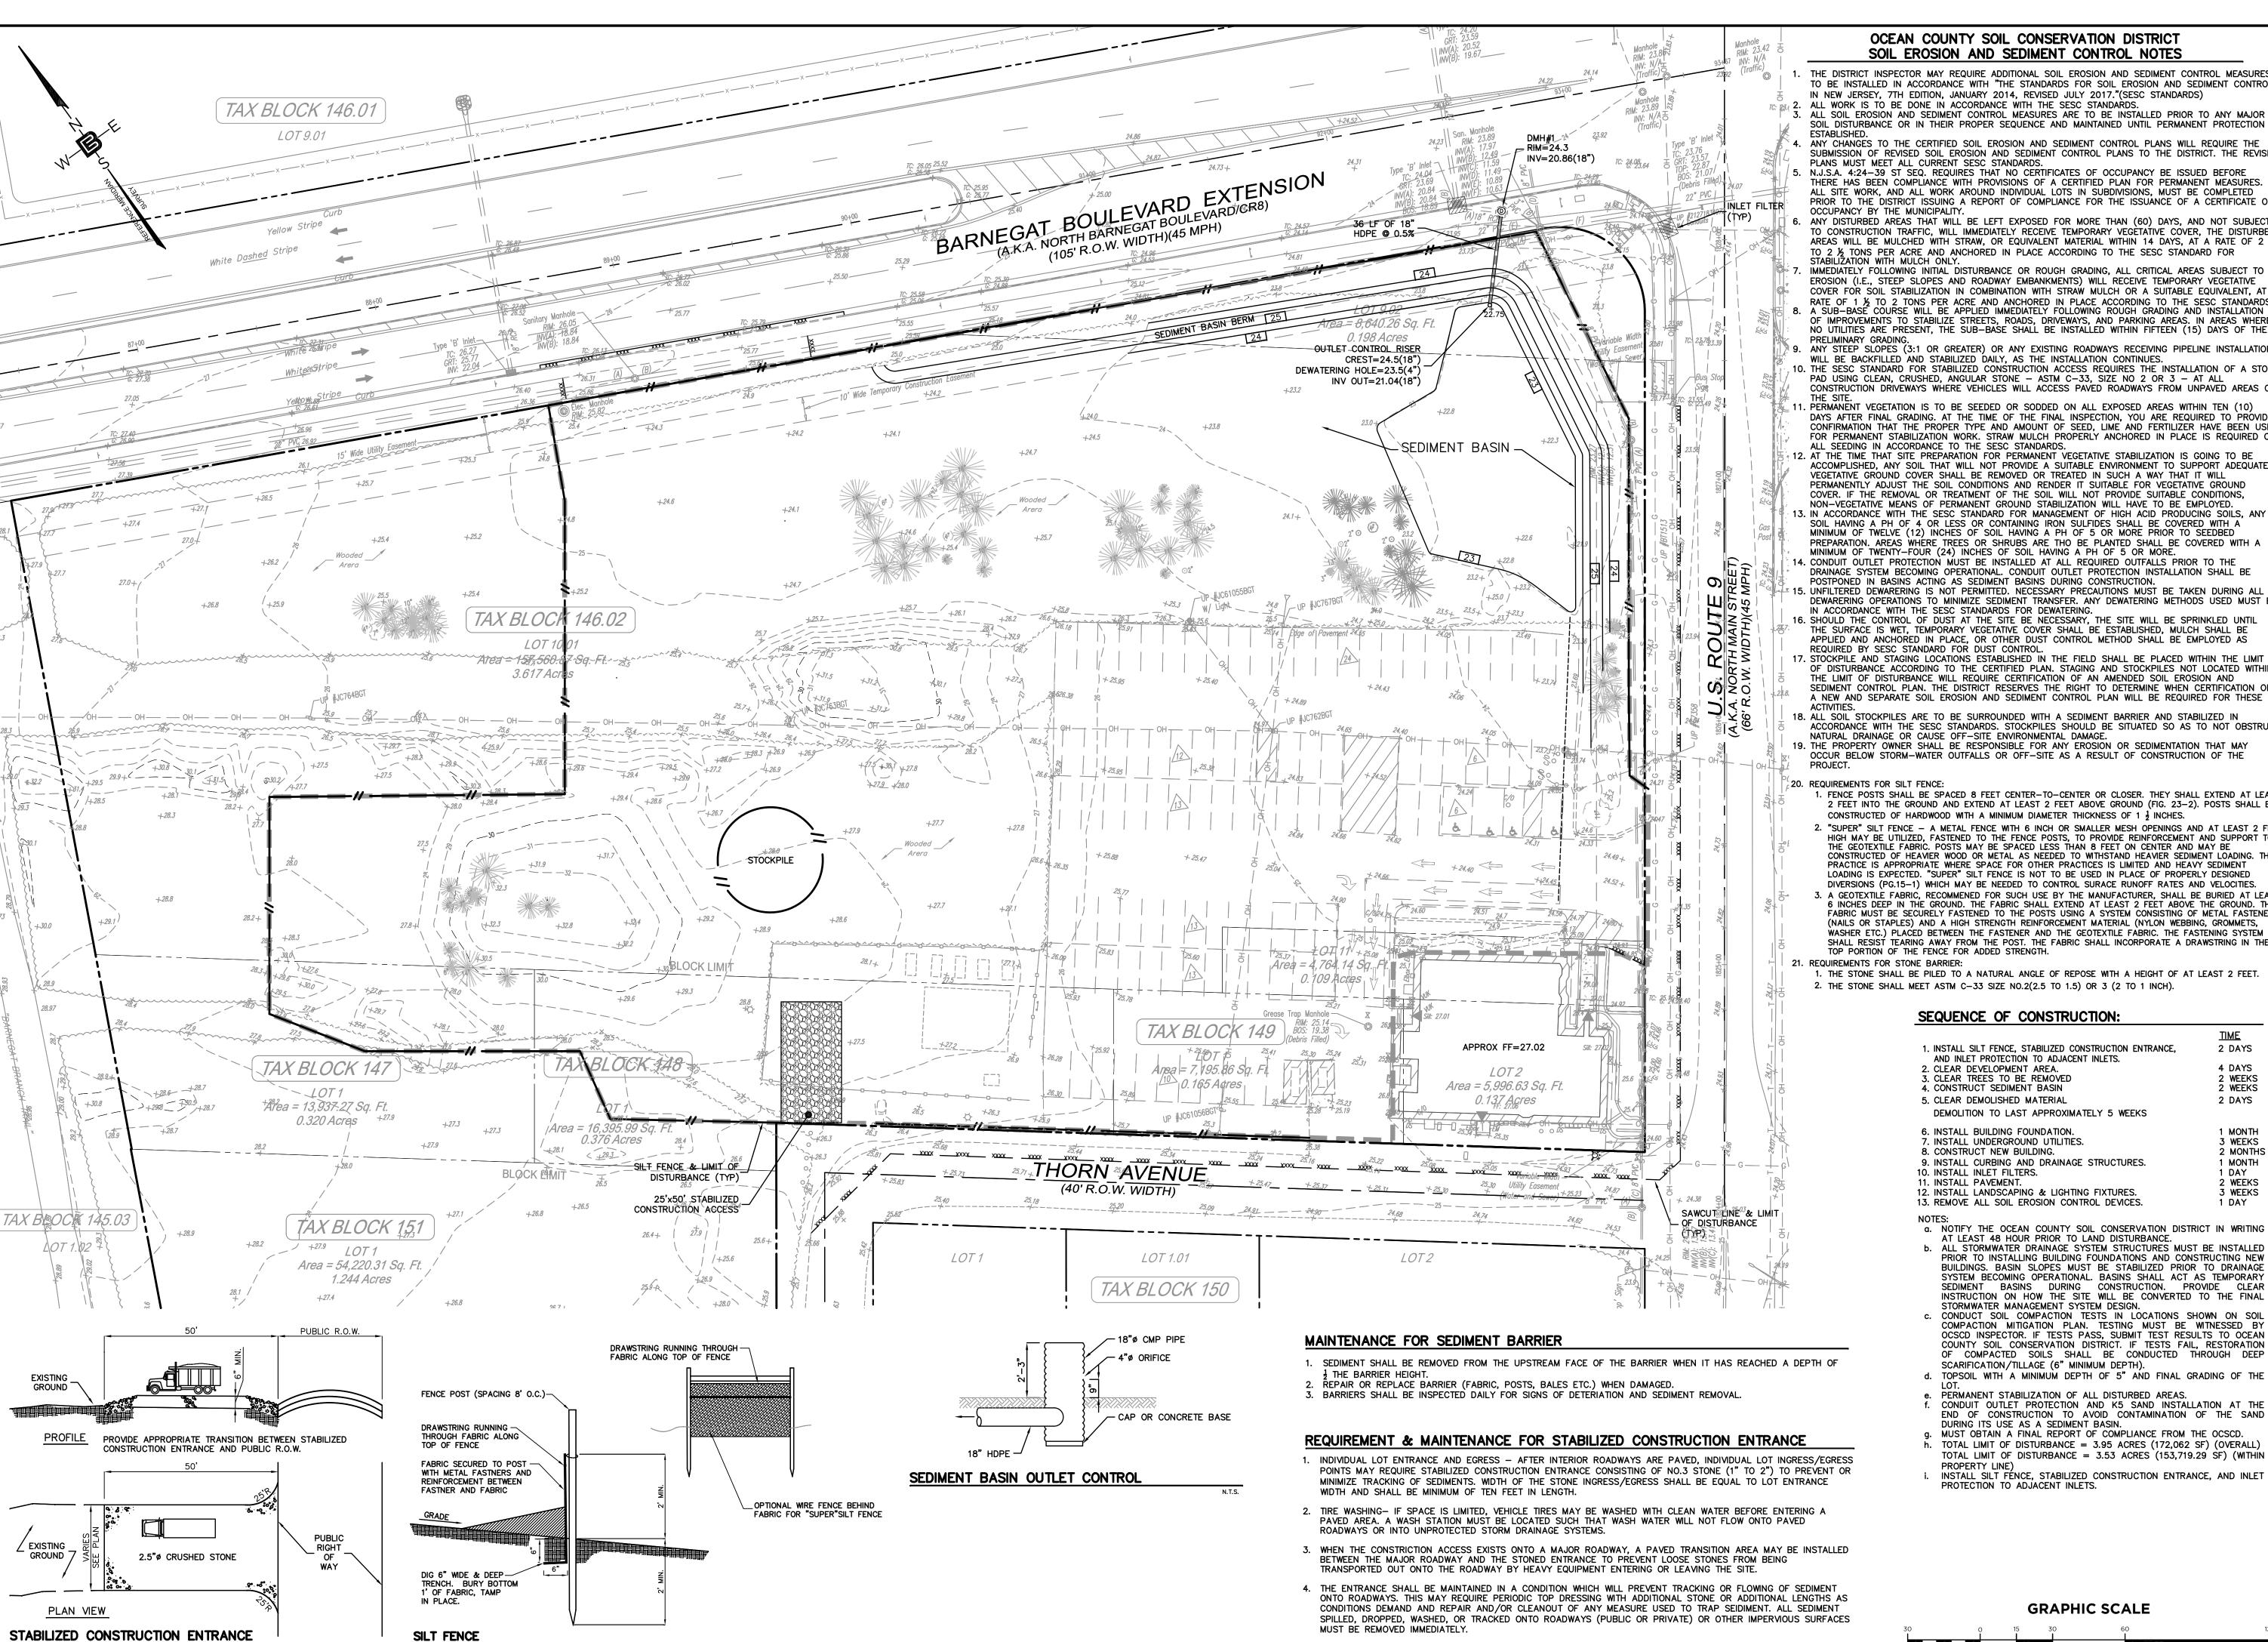

NOT TO SCALE

OCEAN COUNTY SOIL CONSERVATION DISTRICT SOIL EROSION AND SEDIMENT CONTROL NOTES

THE DISTRICT INSPECTOR MAY REQUIRE ADDITIONAL SOIL EROSION AND SEDIMENT CONTROL MEASURES TO BE INSTALLED IN ACCORDANCE WITH "THE STANDARDS FOR SOIL EROSION AND SEDIMENT CONTROL IN NEW JERSEY, 7TH EDITION, JANUARY 2014, REVISED JULY 2017."(SESC STANDARDS)

ALL SOIL EROSION AND SEDIMENT CONTROL MEASURES ARE TO BE INSTALLED PRIOR TO ANY MAJOR SOIL DISTURBANCE OR IN THEIR PROPER SEQUENCE AND MAINTAINED UNTIL PERMANENT PROTECTION IS SUBMISSION OF REVISED SOIL EROSION AND SEDIMENT CONTROL PLANS TO THE DISTRICT. THE REVISED PLANS MUST MEET ALL CURRENT SESC STANDARDS.

N.J.S.A. 4:24-39 ST SEQ. REQUIRES THAT NO CERTIFICATES OF OCCUPANCY BE ISSUED BEFORE THERE HAS BEEN COMPLIANCE WITH PROVISIONS OF A CERTIFIED PLAN FOR PERMANENT MEASURES. ALL SITE WORK, AND ALL WORK AROUND INDIVIDUAL LOTS IN SUBDIVISIONS, MUST BE COMPLETED PRIOR TO THE DISTRICT ISSUING A REPORT OF COMPLIANCE FOR THE ISSUANCE OF A CERTIFICATE O

ANY DISTURBED AREAS THAT WILL BE LEFT EXPOSED FOR MORE THAN (60) DAYS, AND NOT SUBJECT TO CONSTRUCTION TRAFFIC, WILL IMMEDIATELY RECEIVE TEMPORARY VEGETATIVE COVER, THE DISTURBED AREAS WILL BE MULCHED WITH STRAW, OR EQUIVALENT MATERIAL WITHIN 14 DAYS, AT A RATE OF 2 TO 2 1/2 TONS PER ACRE AND ANCHORED IN PLACE ACCORDING TO THE SESC STANDARD FOR STABILIŽATION WITH MULCH ONLY.

IMMEDIATELY FOLLOWING INITIAL DISTURBANCE OR ROUGH GRADING, ALL CRITICAL AREAS SUBJECT TO EROSION (I.E., STEEP SLOPES AND ROADWAY EMBANKMENTS) WILL RECEIVE TEMPORARY VEGETATIVE COVER FOR SOIL STABILIZATION IN COMBINATION WITH STRAW MULCH OR A SUITABLE EQUIVALENT, AT RATE OF 1 ½ TO 2 TONS PER ACRE AND ANCHORED IN PLACE ACCORDING TO THE SESC STANDARDS. A SUB-BASE COURSE WILL BE APPLIED IMMEDIATELY FOLLOWING ROUGH GRADING AND INSTALLATION OF IMPROVEMENTS TO STABILIZE STREETS, ROADS, DRIVEWAYS, AND PARKING AREAS. IN AREAS WHERE NO UTILITIES ARE PRESENT, THE SUB-BASE SHALL BE INSTALLED WITHIN FIFTEEN (15) DAYS OF THE

ANY STEEP SLOPES (3:1 OR GREATER) OR ANY EXISTING ROADWAYS RECEIVING PIPELINE INSTALLATION WILL BE BACKFILLED AND STABILIZED DAILY, AS THE INSTALLATION CONTINUES. 10. THE SESC STANDARD FOR STABILIZED CONSTRUCTION ACCESS REQUIRES THE INSTALLATION OF A STONE PAD USING CLEAN, CRUSHED, ANGULAR STONE - ASTM C-33, SIZE NO 2 OR 3 - AT ALL CONSTRUCTION DRIVEWAYS WHERE VEHICLES WILL ACCESS PAVED ROADWAYS FROM UNPAVED AREAS OF

PERMANENT VEGETATION IS TO BE SEEDED OR SODDED ON ALL EXPOSED AREAS WITHIN TEN (10 DAYS AFTER FINAL GRADING. AT THE TIME OF THE FINAL INSPECTION, YOU ARE REQUIRED TO PROVIDE CONFIRMATION THAT THE PROPER TYPE AND AMOUNT OF SEED, LIME AND FERTILIZER HAVE BEEN USED FOR PERMANENT STABILIZATION WORK. STRAW MULCH PROPERLY ANCHORED IN PLACE IS REQUIRED ON

12. AT THE TIME THAT SITE PREPARATION FOR PERMANENT VEGETATIVE STABILIZATION IS GOING TO BE ACCOMPLISHED, ANY SOIL THAT WILL NOT PROVIDE A SUITABLE ENVIRONMENT TO SUPPORT ADEQUATE VEGETATIVE GROUND COVER SHALL BE REMOVED OR TREATED IN SUCH A WAY THAT IT WILL PERMANENTLY ADJUST THE SOIL CONDITIONS AND RENDER IT SUITABLE FOR VEGETATIVE GROUND COVER. IF THE REMOVAL OR TREATMENT OF THE SOIL WILL NOT PROVIDE SUITABLE CONDITIONS. NON-VEGETATIVE MEANS OF PERMANENT GROUND STABILIZATION WILL HAVE TO BE EMPLOYED. 13. IN ACCORDANCE WITH THE SESC STANDARD FOR MANAGEMENT OF HIGH ACID PRODUCING SOILS, ANY SOIL HAVING A PH OF 4 OR LESS OR CONTAINING IRON SULFIDES SHALL BE COVERED WITH A MINIMUM OF TWELVE (12) INCHES OF SOIL HAVING A PH OF 5 OR MORE PRIOR TO SEEDBED

PREPARATION. AREAS WHERE TREES OR SHRUBS ARE THO BE PLANTED SHALL BE COVERED WITH A MINIMUM OF TWENTY-FOUR (24) INCHES OF SOIL HAVING A PH OF 5 OR MORE. 4. CONDUIT OUTLET PROTECTION MUST BE INSTALLED AT ALL REQUIRED OUTFALLS PRIOR TO THE DRAINAGE SYSTEM BECOMING OPERATIONAL. CONDUIT OUTLET PROTECTION INSTALLATION SHALL BE POSTPONED IN BASINS ACTING AS SEDIMENT BASINS DURING CONSTRUCTION.

DEWARERING OPERATIONS TO MINIMIZE SEDIMENT TRANSFER. ANY DEWATERING METHODS USED MUST B IN ACCORDANCE WITH THE SESC STANDARDS FOR DEWATERING. 16. SHOULD THE CONTROL OF DUST AT THE SITE BE NECESSARY, THE SITE WILL BE SPRINKLED UNTIL THE SURFACE IS WET, TEMPORARY VEGETATIVE COVER SHALL BE ESTABLISHED, MULCH SHALL BE

APPLIED AND ANCHORED IN PLACE, OR OTHER DUST CONTROL METHOD SHALL BE EMPLOYED AS REQUIRED BY SESC STANDARD FOR DUST CONTROL. 17. STOCKPILE AND STAGING LOCATIONS ESTABLISHED IN THE FIELD SHALL BE PLACED WITHIN THE LIMIT OF DISTURBANCE ACCORDING TO THE CERTIFIED PLAN. STAGING AND STOCKPILES NOT LOCATED WITHIN NH LIC. NO. 9368 RI LIC. NO. 669 THE LIMIT OF DISTURBANCE WILL REQUIRE CERTIFICATION OF AN AMENDED SOIL EROSION AND SEDIMENT CONTROL PLAN. THE DISTRICT RESERVES THE RIGHT TO DETERMINE WHEN CERTIFICATION OF

18. ALL SOIL STOCKPILES ARE TO BE SURROUNDED WITH A SEDIMENT BARRIER AND STABILIZED IN ACCORDANCE WITH THE SESC STANDARDS. STOCKPILES SHOULD BE SITUATED SO AS TO NOT OBSTRUC NATURAL DRAINAGE OR CAUSE OFF-SITE ENVIRONMENTAL DAMAGE. 19. THE PROPERTY OWNER SHALL BE RESPONSIBLE FOR ANY EROSION OR SEDIMENTATION THAT MAY

OCCUR BELOW STORM-WATER OUTFALLS OR OFF-SITE AS A RESULT OF CONSTRUCTION OF THE

1. FENCE POSTS SHALL BE SPACED 8 FEET CENTER-TO-CENTER OR CLOSER. THEY SHALL EXTEND AT LEAS' 2 FEET INTO THE GROUND AND EXTEND AT LEAST 2 FEET ABOVE GROUND (FIG. 23-2). POSTS SHALL BE CONSTRUCTED OF HARDWOOD WITH A MINIMUM DIAMETER THICKNESS OF 1 ½ INCHES. 2. "SUPER" SILT FENCE - A METAL FENCE WITH 6 INCH OR SMALLER MESH OPENINGS AND AT LEAST 2 FEE

HIGH MAY BE UTILIZED, FASTENED TO THE FENCE POSTS, TO PROVIDE REINFORCEMENT AND SUPPORT T THE GEOTEXTILE FABRIC. POSTS MAY BE SPACED LESS THAN 8 FEET ON CENTER AND MAY BE CONSTRUCTED OF HEAVIER WOOD OR METAL AS NEEDED TO WITHSTAND HEAVIER SEDIMENT LOADING. THIS PRACTICE IS APPROPRIATE WHERE SPACE FOR OTHER PRACTICES IS LIMITED AND HEAVY SEDIMENT LOADING IS EXPECTED. "SUPER" SILT FENCE IS NOT TO BE USED IN PLACE OF PROPERLY DESIGNED DIVERSIONS (PG.15-1) WHICH MAY BE NEEDED TO CONTROL SURACE RUNOFF RATES AND VELOCITIES.

6 INCHES DEEP IN THE GROUND. THE FABRIC SHALL EXTEND AT LEAST 2 FEET ABOVE THE GROUND. THE FABRIC MUST BE SECURELY FASTENED TO THE POSTS USING A SYSTEM CONSISTING OF METAL FASTENER (NAILS OR STAPLES) AND A HIGH STRENGTH REINFORCEMENT MATERIAL (NYLON WEBBING, GROMMETS, WASHER ETC.) PLACED BETWEEN THE FASTENER AND THE GEOTEXTILE FABRIC. THE FASTENING SYSTEM SHALL RESIST TEARING AWAY FROM THE POST. THE FABRIC SHALL INCORPORATE A DRAWSTRING IN THE TOP PORTION OF THE FENCE FOR ADDED STRENGTH.

1. THE STONE SHALL BE PILED TO A NATURAL ANGLE OF REPOSE WITH A HEIGHT OF AT LEAST 2 FEET. 2. THE STONE SHALL MEET ASTM C-33 SIZE NO.2(2.5 TO 1.5) OR 3 (2 TO 1 INCH).

SEQUENCE OF CONSTRUCTION:

 INSTALL SILT FENCE, STABILIZED CONSTRUCTION ENTRANCE, AND INLET PROTECTION TO ADJACENT INLETS. 	2 DAYS
2. CLEAR DEVELOPMENT AREA.	4 DAYS
3. CLEAR TREES TO BE REMOVED	2 WEEKS
4. CONSTRUCT SEDIMENT BASIN	2 WEEKS
5. CLEAR DEMOLISHED MATERIAL	2 DAYS
DEMOLITION TO LAST APPROXIMATELY 5 WEEKS	
6. INSTALL BUILDING FOUNDATION.	1 MONTH
7. INSTALL UNDERGROUND UTILITIES.	3 WEEKS
8. CONSTRUCT NEW BUILDING.	2 MONTHS
9. INSTALL CURBING AND DRAINAGE STRUCTURES.	1 MONTH
10. INSTALL INLET FILTERS.	1 DAY
11. INSTALL PAVEMENT.	2 WEEKS
12 INSTALL LANDSCAPING & LIGHTING FIXTURES	3 WFFKS

<u>TIME</u>

5. WHERE ACCUMULATION OF DUST/SEDIMENT IS INADEQUTELY CLEANED OR REMOVED BY CONVENTIONAL METHODS, A

ACCESS POINTS WHICH ARE NOT STABILIZED SHALL BE BLOCKED OFF.

POWER BROOM OR STREET SWEEPER WILL BE REQUIRED TO CLEAN PAVED OR IMPERVIOUS SURFACES. ALL OTHER

- a. NOTIFY THE OCEAN COUNTY SOIL CONSERVATION DISTRICT IN WRITING AT LEAST 48 HOUR PRIOR TO LAND DISTURBANCE. b. ALL STORMWATER DRAINAGE SYSTEM STRUCTURES MUST BE INSTALLED PRIOR TO INSTALLING BUILDING FOUNDATIONS AND CONSTRUCTING NEW BUILDINGS. BASIN SLOPES MUST BE STABILIZED PRIOR TO DRAINAGE SYSTEM BECOMING OPERATIONAL. BASINS SHALL ACT AS TEMPORARY SEDIMENT BASINS DURING CONSTRUCTION. PROVIDE CLEAR INSTRUCTION ON HOW THE SITE WILL BE CONVERTED TO THE FINAL STORMWATER MANAGEMENT SYSTEM DESIGN.
- c. CONDUCT SOIL COMPACTION TESTS IN LOCATIONS SHOWN ON SOIL COMPACTION MITIGATION PLAN. TESTING MUST BE WITNESSED BY OCSCD INSPECTOR. IF TESTS PASS, SUBMIT TEST RESULTS TO OCEAN COUNTY SOIL CONSERVATION DISTRICT. IF TESTS FAIL, RESTORATION OF COMPACTED SOILS SHALL BE CONDUCTED THROUGH DEEP SCARIFICATION/TILLAGE (6" MINIMUM DEPTH).
- d. TOPSOIL WITH A MINIMUM DEPTH OF 5" AND FINAL GRADING OF THE
- e. PERMANENT STABILIZATION OF ALL DISTURBED AREAS. CONDUIT OUTLET PROTECTION AND K5 SAND INSTALLATION AT THE END OF CONSTRUCTION TO AVOID CONTAMINATION OF THE SAND
- DURING ITS USE AS A SEDIMENT BASIN. . MUST OBTAIN A FINAL REPORT OF COMPLIANCE FROM THE OCSCD. TOTAL LIMIT OF DISTURBANCE = 3.95 ACRES (172,062 SF) (OVERALL) TOTAL LIMIT OF DISTURBANCE = 3.53 ACRES (153,719.29 SF) (WITHIN
- PROPERTY LINE) INSTALL SILT FÉNCE, STABILIZED CONSTRUCTION ENTRANCE, AND INLET PROTECTION TO ADJACENT INLETS.

M&T AT 547 MAIN LLC 1260 STELTON ROAD

	24GA28068900 / 21MH00002800		
	DRAWN BY	CHECKED BY	
	V.L.	C.J.B.	
	SCALE 1"=30'	PROJECT NO. 21-312	
	DATE	REVISION NO.	
)	1-31-24	3	
	DRAWING NO.	-	

C2.3A

GRAPHIC SCALE

1 inch = 30 ft.

(IN FEET)

SOIL EROSION SEDIMENT

CALISTO J. BERTIN, P.E.

PROFESSIONAL ENGINEER

MA LIC. NO. 40595 NY LIC. NO. 6002

SHAN-PEI FANCHIANG, P.:

PROFESSIONAL ENGINEER


NJ LIC. NO. 37073 NY LIC. NO. 071209


CONTROL PLAN

WaWa Food Market & Fueling Station

LOCK 148, LOT 1, BLOCK 149, LOTS 1 & 2, BLOCK 151, LOT 547 NORTH MAIN STREET TWSP OF BARNEGAT, OCEAN COUNTY, N

C/O EDGEWOOD PROPERTIES, INC PISCATAWAY, NJ 08854

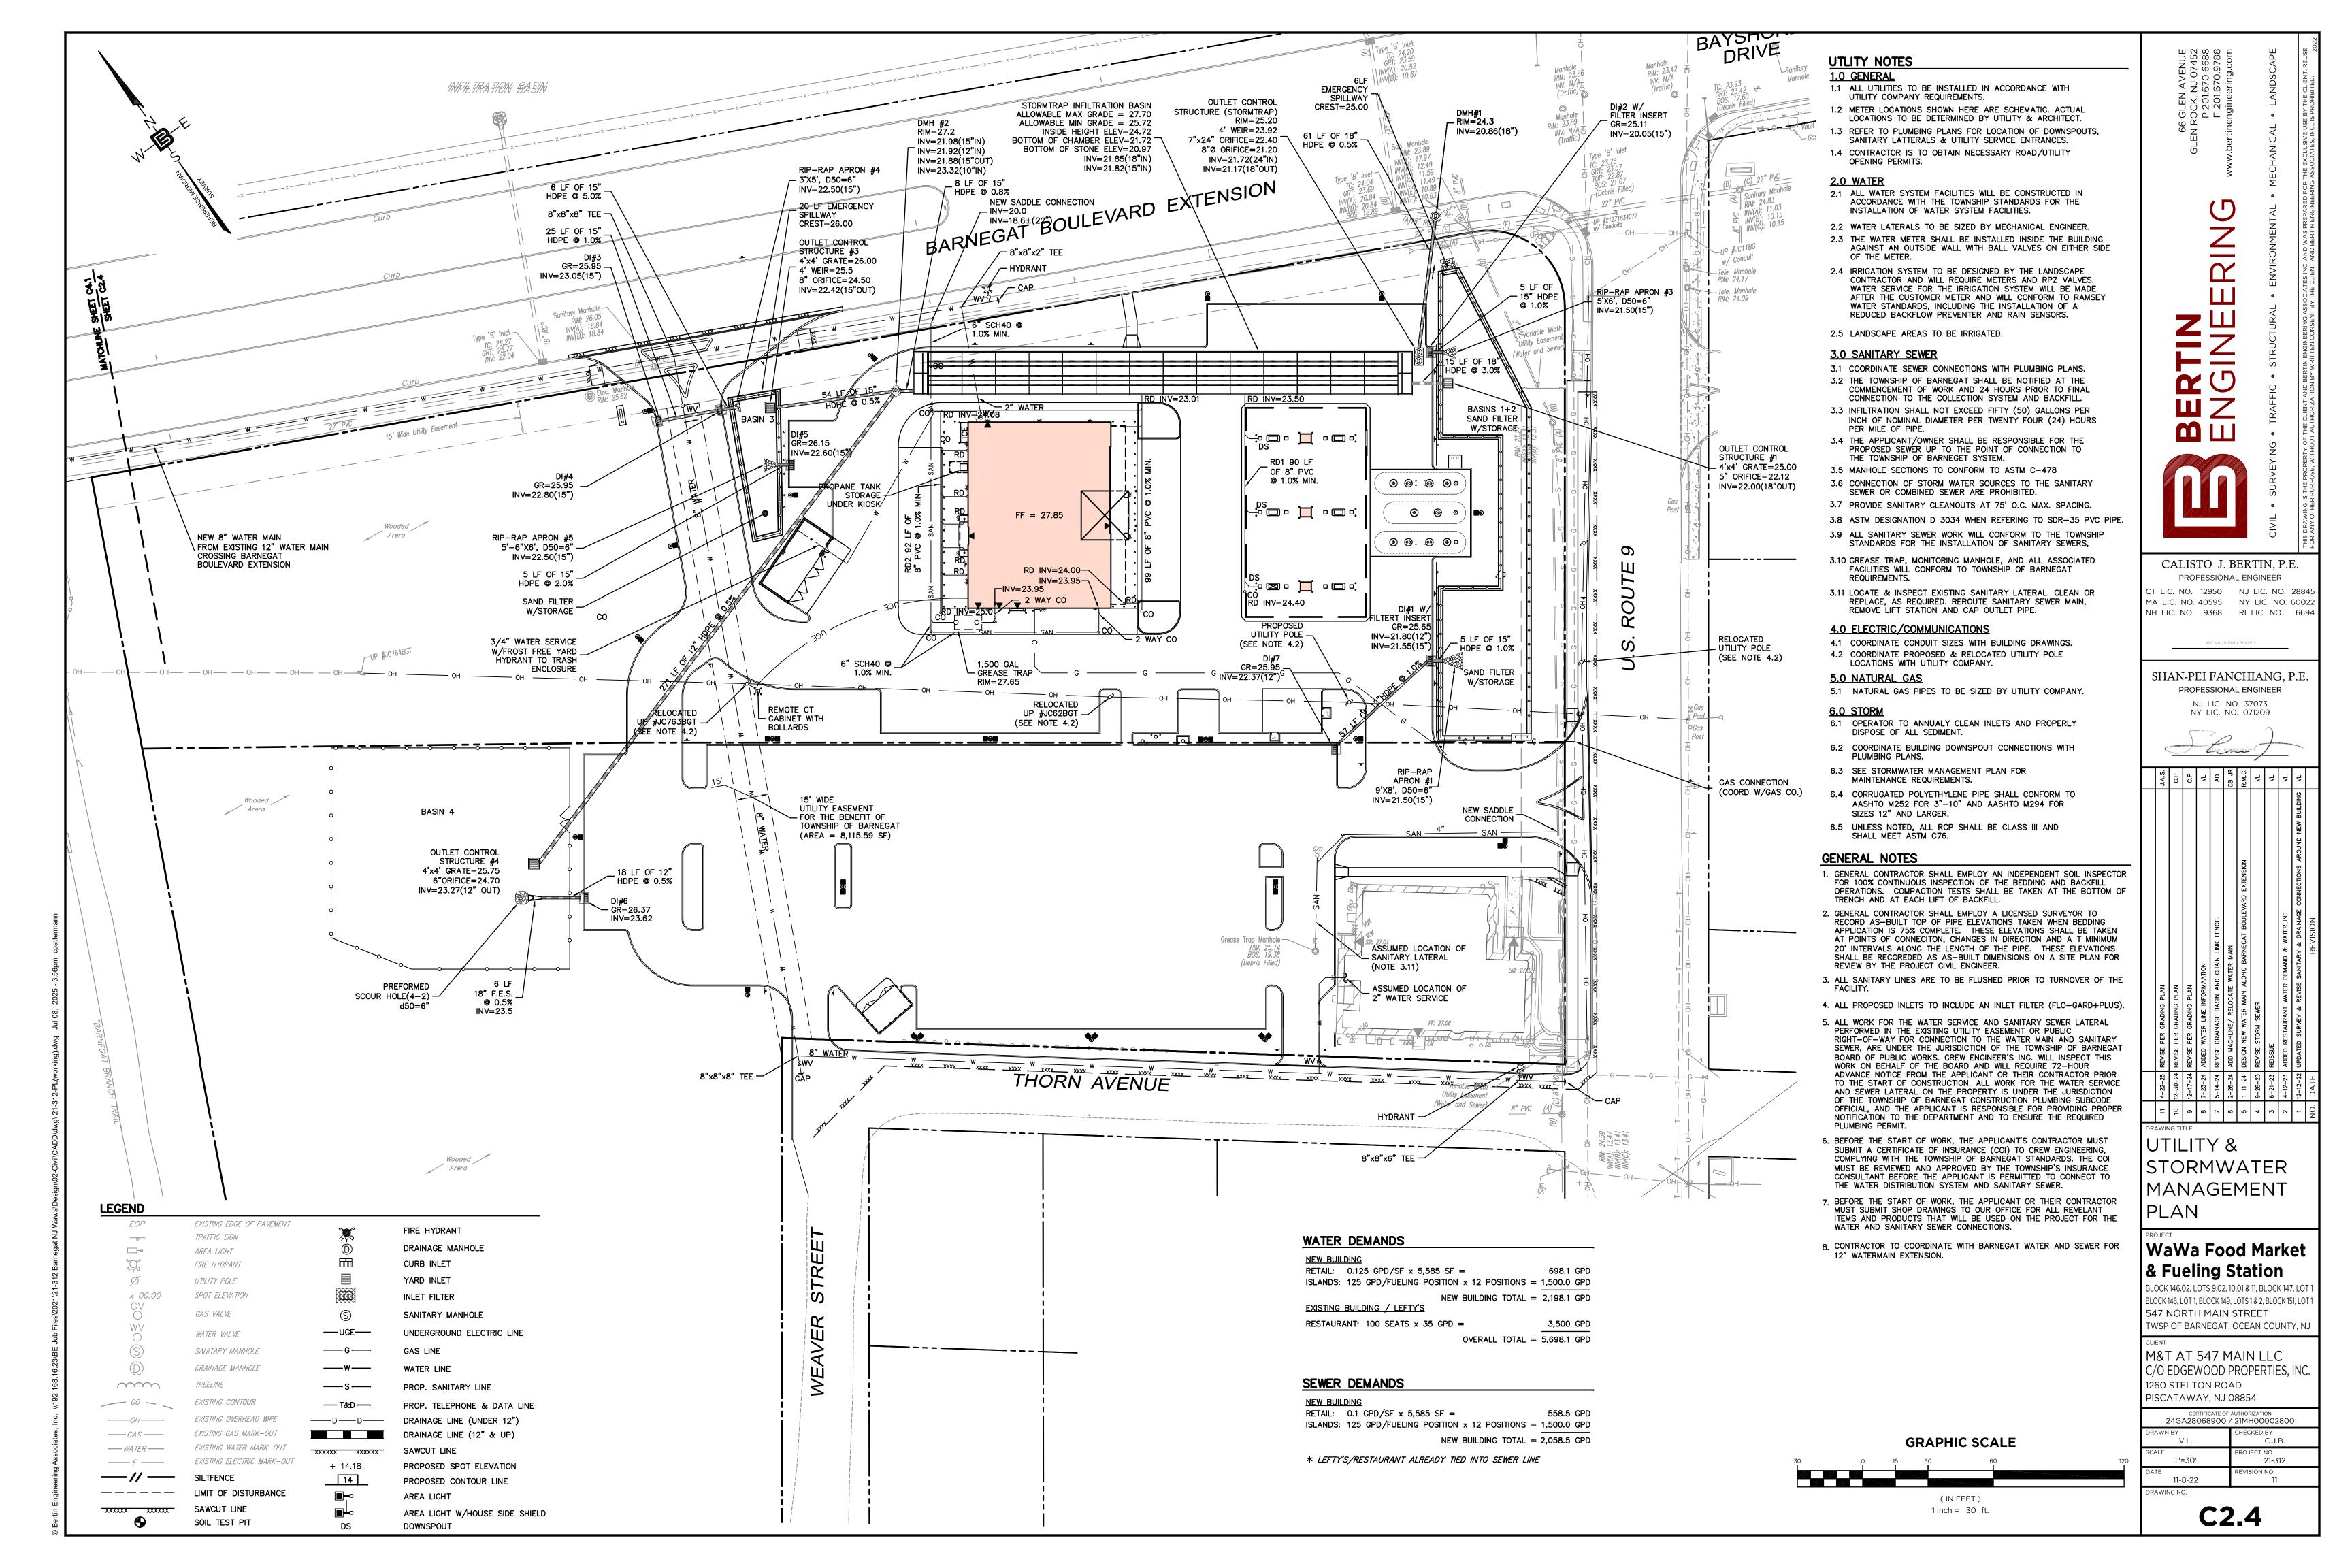

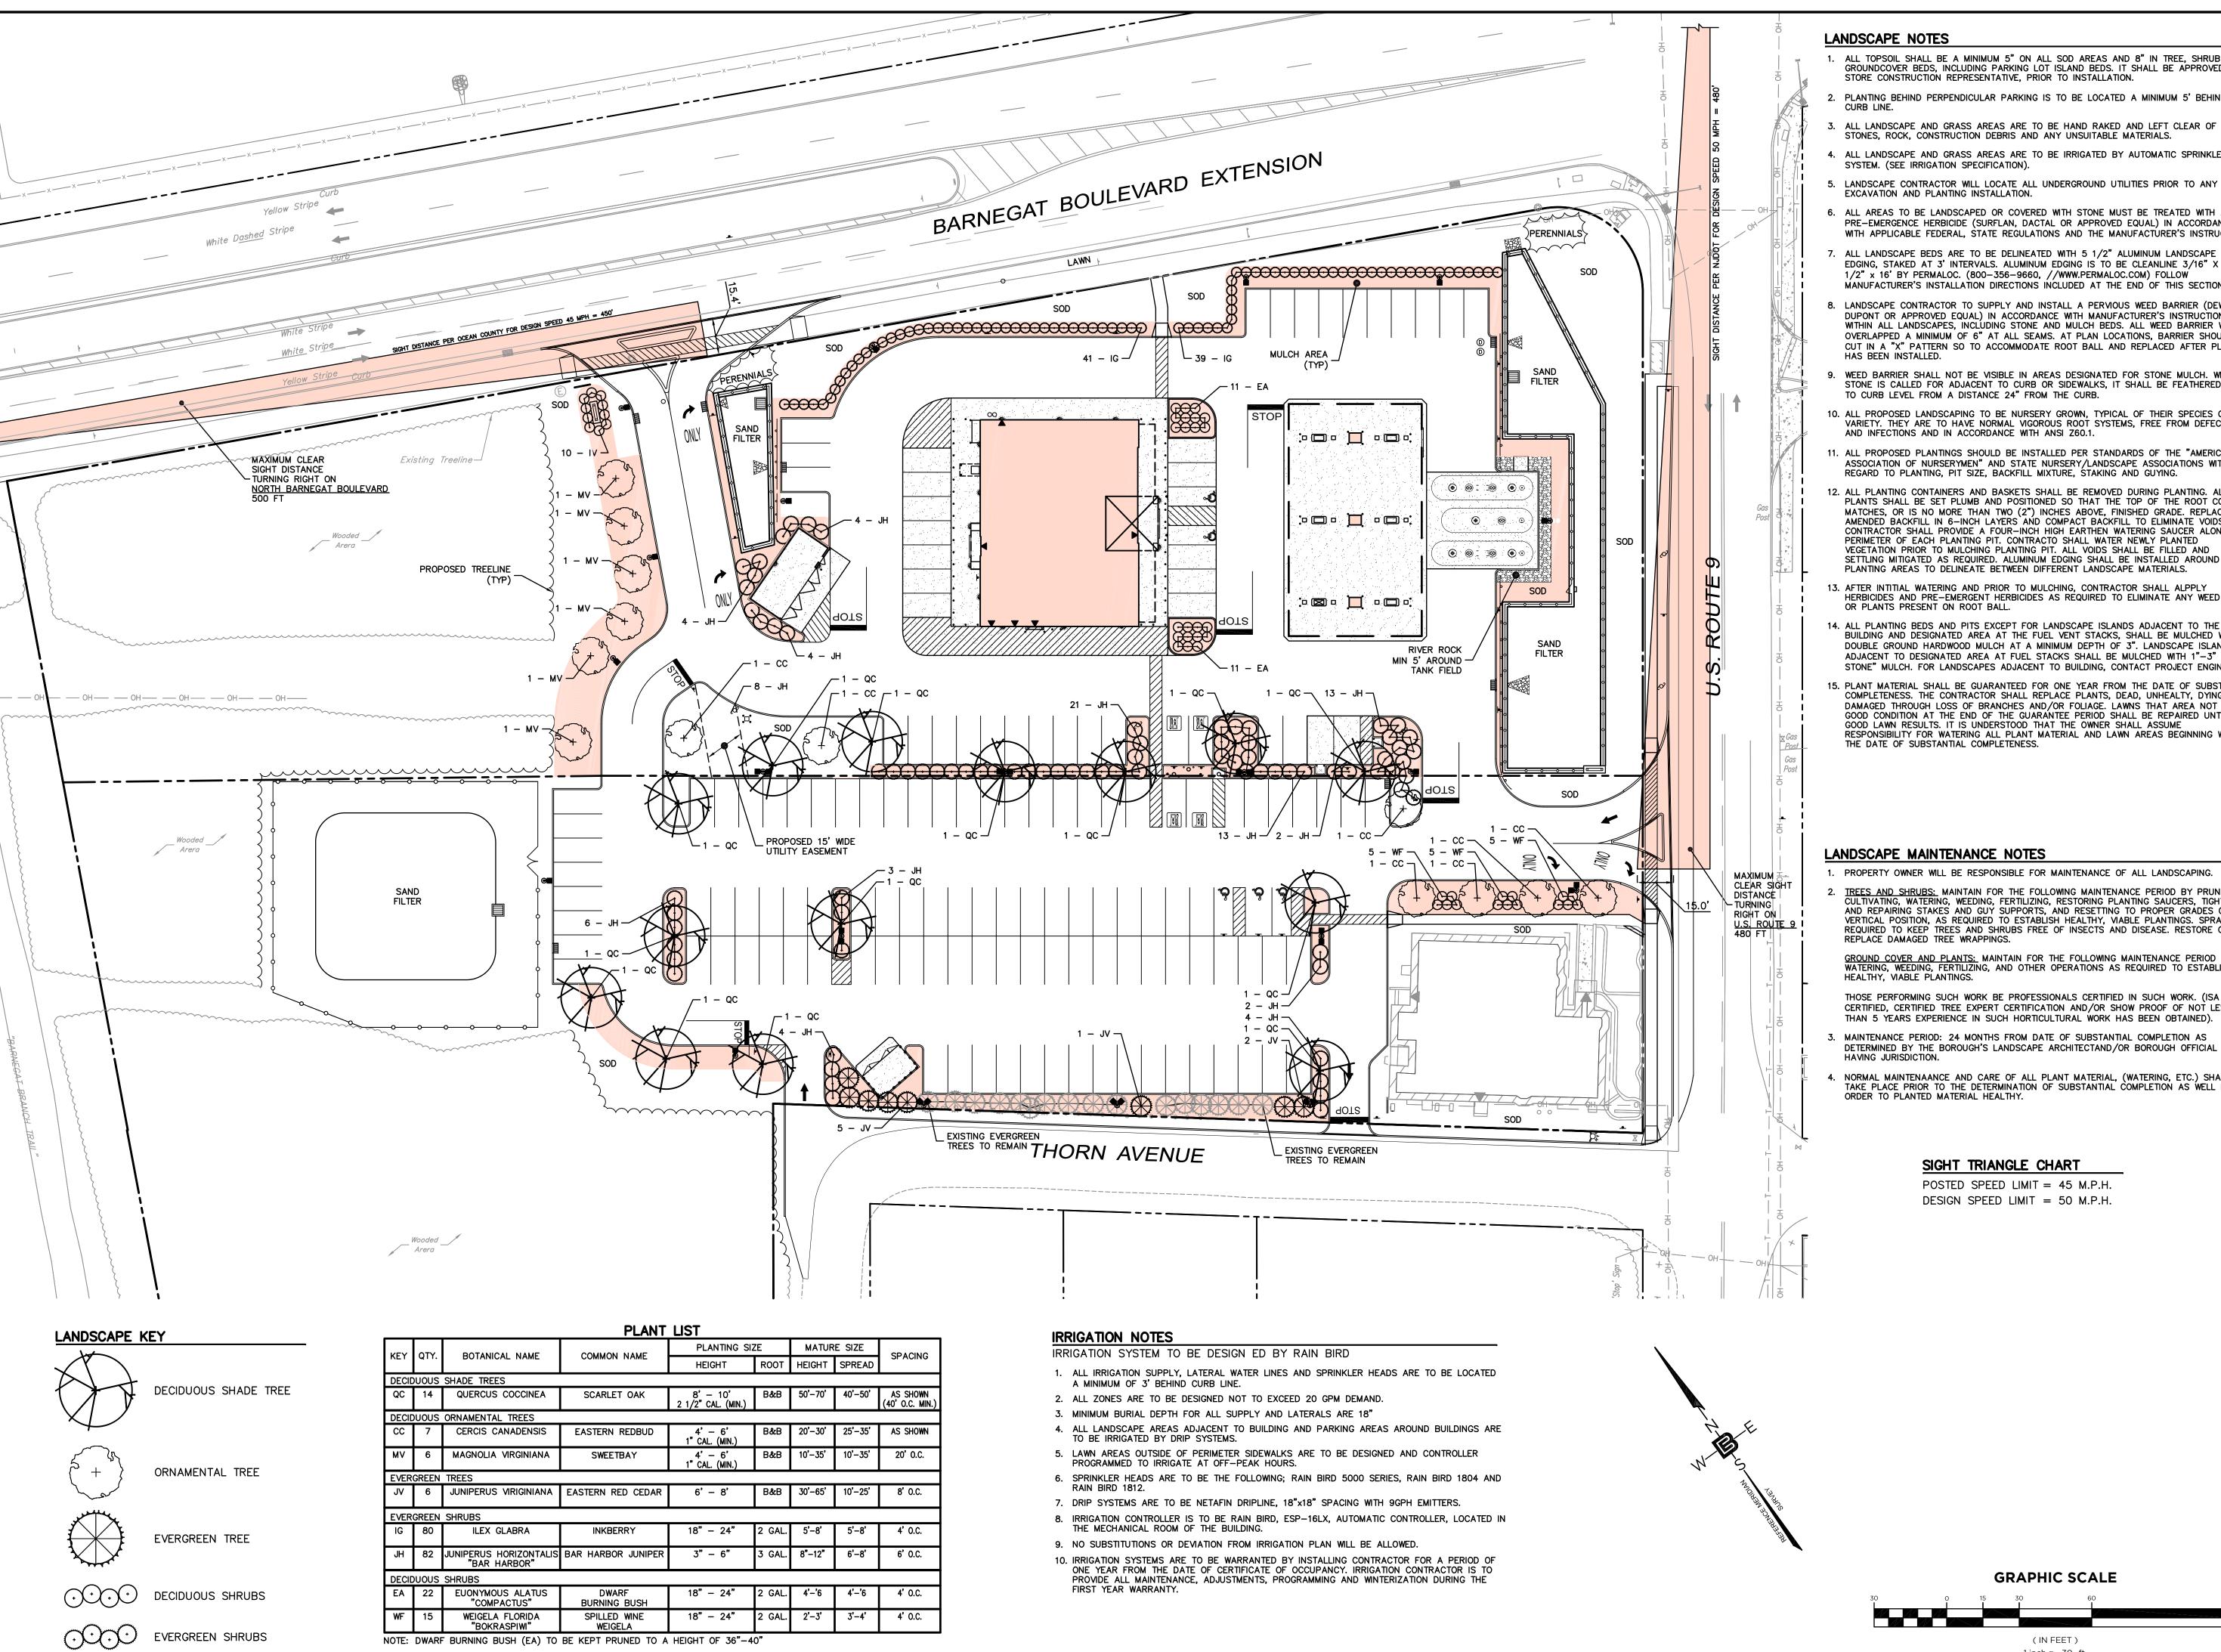

- ALL TOPSOIL SHALL BE A MINIMUM 5" ON ALL SOD AREAS AND 8" IN TREE, SHRUB AND GROUNDCOVER BEDS, INCLUDING PARKING LOT ISLAND BEDS. IT SHALL BE APPROVED BY A STORE CONSTRUCTION REPRESENTATIVE, PRIOR TO INSTALLATION.
- 2. PLANTING BEHIND PERPENDICULAR PARKING IS TO BE LOCATED A MINIMUM 5' BEHIND THE
- 3. ALL LANDSCAPE AND GRASS AREAS ARE TO BE HAND RAKED AND LEFT CLEAR OF ALL
- ALL LANDSCAPE AND GRASS AREAS ARE TO BE IRRIGATED BY AUTOMATIC SPRINKLER
- SYSTEM. (SEE IRRIGATION SPECIFICATION).
- 6. ALL AREAS TO BE LANDSCAPED OR COVERED WITH STONE MUST BE TREATED WITH A PRE-EMERGENCE HERBICIDE (SURFLAN, DACTAL OR APPROVED EQUAL) IN ACCORDANCE WITH APPLICABLE FEDERAL, STATE REGULATIONS AND THE MANUFACTURER'S INSTRUCTIONS.
- ALL LANDSCAPE BEDS ARE TO BE DELINEATED WITH 5 1/2" ALUMINUM LANDSCAPE EDGING, STAKED AT 3' INTERVALS, ALUMINUM EDGING IS TO BE CLEANLINE 3/16" X 5 1/2" x 16' BY PERMALOC. (800-356-9660, //WWW.PERMALOC.COM) FOLLOW MANUFACTURER'S INSTALLATION DIRECTIONS INCLUDED AT THE END OF THIS SECTION.
- 8. LANDSCAPE CONTRACTOR TO SUPPLY AND INSTALL A PERVIOUS WEED BARRIER (DEWITT, DUPONT OR APPROVED EQUAL) IN ACCORDANCE WITH MANUFACTURER'S INSTRUCTIONS WITHIN ALL LANDSCAPES, INCLUDING STONE AND MULCH BEDS. ALL WEED BARRIER WILL BE OVERLAPPED A MINIMUM OF 6" AT ALL SEAMS. AT PLAN LOCATIONS, BARRIER SHOULD BE CUT IN A "X" PATTERN SO TO ACCOMMODATE ROOT BALL AND REPLACED AFTER PLANT
- 9. WEED BARRIER SHALL NOT BE VISIBLE IN AREAS DESIGNATED FOR STONE MULCH. WHEN STONE IS CALLED FOR ADJACENT TO CURB OR SIDEWALKS, IT SHALL BE FEATHERED DOWN TO CURB LEVEL FROM A DISTANCE 24" FROM THE CURB.
- 10. ALL PROPOSED LANDSCAPING TO BE NURSERY GROWN, TYPICAL OF THEIR SPECIES OR VARIETY. THEY ARE TO HAVE NORMAL VIGOROUS ROOT SYSTEMS, FREE FROM DEFECTS AND INFECTIONS AND IN ACCORDANCE WITH ANSI Z60.1.
- 11. ALL PROPOSED PLANTINGS SHOULD BE INSTALLED PER STANDARDS OF THE "AMERICAN ASSOCIATION OF NURSERYMEN" AND STATE NURSERY/LANDSCAPE ASSOCIATIONS WITH REGARD TO PLANTING, PIT SIZE, BACKFILL MIXTURE, STAKING AND GUYING.
- 12. ALL PLANTING CONTAINERS AND BASKETS SHALL BE REMOVED DURING PLANTING. ALL PLANTS SHALL BE SET PLUMB AND POSITIONED SO THAT THE TOP OF THE ROOT COLLAR MATCHES, OR IS NO MORE THAN TWO (2") INCHES ABOVE, FINISHED GRADE. REPLACE AMENDED BACKFILL IN 6-INCH LAYERS AND COMPACT BACKFILL TO ELIMINATE VOIDS. CONTRACTOR SHALL PROVIDE A FOUR-INCH HIGH EARTHEN WATERING SAUCER ALONG THE PERIMETER OF EACH PLANTING PIT. CONTRACTO SHALL WATER NEWLY PLANTED VEGETATION PRIOR TO MULCHING PLANTING PIT. ALL VOIDS SHALL BE FILLED AND SETTLING MITIGATED AS REQUIRED. ALUMINUM EDGING SHALL BE INSTALLED AROUND ALL PLANTING AREAS TO DELINEATE BETWEEN DIFFERENT LANDSCAPE MATERIALS.
- 13. AFTER INTITIAL WATERING AND PRIOR TO MULCHING, CONTRACTOR SHALL ALPPLY HERBICIDES AND PRE-EMERGENT HERBICIDES AS REQUIRED TO ELIMINATE ANY WEED SEEDS OR PLANTS PRESENT ON ROOT BALL.
- 14. ALL PLANTING BEDS AND PITS EXCEPT FOR LANDSCAPE ISLANDS ADJACENT TO THE BUILDING AND DESIGNATED AREA AT THE FUEL VENT STACKS, SHALL BE MULCHED WITH DOUBLE GROUND HARDWOOD MULCH AT A MINIMUM DEPTH OF 3". LANDSCAPE ISLANDS ADJACENT TO DESIGNATED AREA AT FUEL STACKS SHALL BE MULCHED WITH 1"-3" "RIVER STONE" MULCH. FOR LANDSCAPES ADJACENT TO BUILDING, CONTACT PROJECT ENGINEER.
- 15. PLANT MATERIAL SHALL BE GUARANTEED FOR ONE YEAR FROM THE DATE OF SUBSTANTIAL COMPLETENESS. THE CONTRACTOR SHALL REPLACE PLANTS, DEAD, UNHEALTY, DYING OR DAMAGED THROUGH LOSS OF BRANCHES AND/OR FOLIAGE. LAWNS THAT AREA NOT IN GOOD CONDITION AT THE END OF THE GUARANTEE PERIOD SHALL BE REPAIRED UNTIL A GOOD LAWN RESULTS. IT IS UNDERSTOOD THAT THE OWNER SHALL ASSUME RESPONSIBILITY FOR WATERING ALL PLANT MATERIAL AND LAWN AREAS BEGINNING WITH THE DATE OF SUBSTANTIAL COMPLETENESS.

LANDSCAPE MAINTENANCE NOTES

1. PROPERTY OWNER WILL BE RESPONSIBLE FOR MAINTENANCE OF ALL LANDSCAPING.

TREES AND SHRUBS: MAINTAIN FOR THE FOLLOWING MAINTENANCE PERIOD BY PRUNING, CULTIVATING, WATERING, WEEDING, FERTILIZING, RESTORING PLANTING SAUCERS, TIGHTENING AND REPAIRING STAKES AND GUY SUPPORTS, AND RESETTING TO PROPER GRADES OR VERTICAL POSITION, AS REQUIRED TO ESTABLISH HEALTHY, VIABLE PLANTINGS. SPRAY AS REQUIRED TO KEEP TREES AND SHRUBS FREE OF INSECTS AND DISEASE. RESTORE OR REPLACE DAMAGED TREE WRAPPINGS.

<u>GROUND COVER AND PLANTS:</u> MAINTAIN FOR THE FOLLOWING MAINTENANCE PERIOD BY WATERING, WEEDING, FERTILIZING, AND OTHER OPERATIONS AS REQUIRED TO ESTABLISH

- THOSE PERFORMING SUCH WORK BE PROFESSIONALS CERTIFIED IN SUCH WORK. (ISA CERTIFIED, CERTIFIED TREE EXPERT CERTIFICATION AND/OR SHOW PROOF OF NOT LESS THAN 5 YEARS EXPERIENCE IN SUCH HORTICULTURAL WORK HAS BEEN OBTAINED).
- MAINTENANCE PERIOD: 24 MONTHS FROM DATE OF SUBSTANTIAL COMPLETION AS DETERMINED BY THE BOROUGH'S LANDSCAPE ARCHITECTAND/OR BOROUGH OFFICIAL
- 4. NORMAL MAINTENAANCE AND CARE OF ALL PLANT MATERIAL, (WATERING, ETC.) SHALL TAKE PLACE PRIOR TO THE DETERMINATION OF SUBSTANTIAL COMPLETION AS WELL IN ORDER TO PLANTED MATERIAL HEALTHY.

SIGHT TRIANGLE CHART

POSTED SPEED LIMIT = 45 M.P.H. DESIGN SPEED LIMIT = 50 M.P.H.

GRAPHIC SCALE

(IN FEET) 1 inch = 30 ft.

LANDSCAPE & SIGHT **TRIANGLE** PLAN

CALISTO J. BERTIN, P.E.

PROFESSIONAL ENGINEER

I LIC. NO. 12950 NJ LIC. NO. 28845

MA LIC. NO. 40595 NY LIC. NO. 60022

NH LIC. NO. 9368 RI LIC. NO. 6694

SHAN-PEI FANCHIANG, P.I

PROFESSIONAL ENGINEER

NJ LIC. NO. 37073 NY LIC. NO. 071209

CINCLIDE STREET


WaWa Food Market & Fueling Station


BLOCK 146.02, LOTS 9.02, 10.01 & 11, BLOCK 147, LO BLOCK 148, LOT 1, BLOCK 149, LOTS 1 & 2, BLOCK 151, LOT 547 NORTH MAIN STREET TWSP OF BARNEGAT, OCEAN COUNTY, N.


M&T AT 547 MAIN LLC C/O EDGEWOOD PROPERTIES, INC 1260 STELTON ROAD PISCATAWAY, NJ 08854


CERTIFICATE OF AUTHORIZATION 24GA28068900 / 21MH00002800		
DRAWN BY	CHECKED BY	
V.L.	C.J.B.	
SCALE 1"=30'	PROJECT NO. 21-312	
DATE 11-8-22	REVISION NO.	
DRAWING NO.	<u> </u>	


C2.5

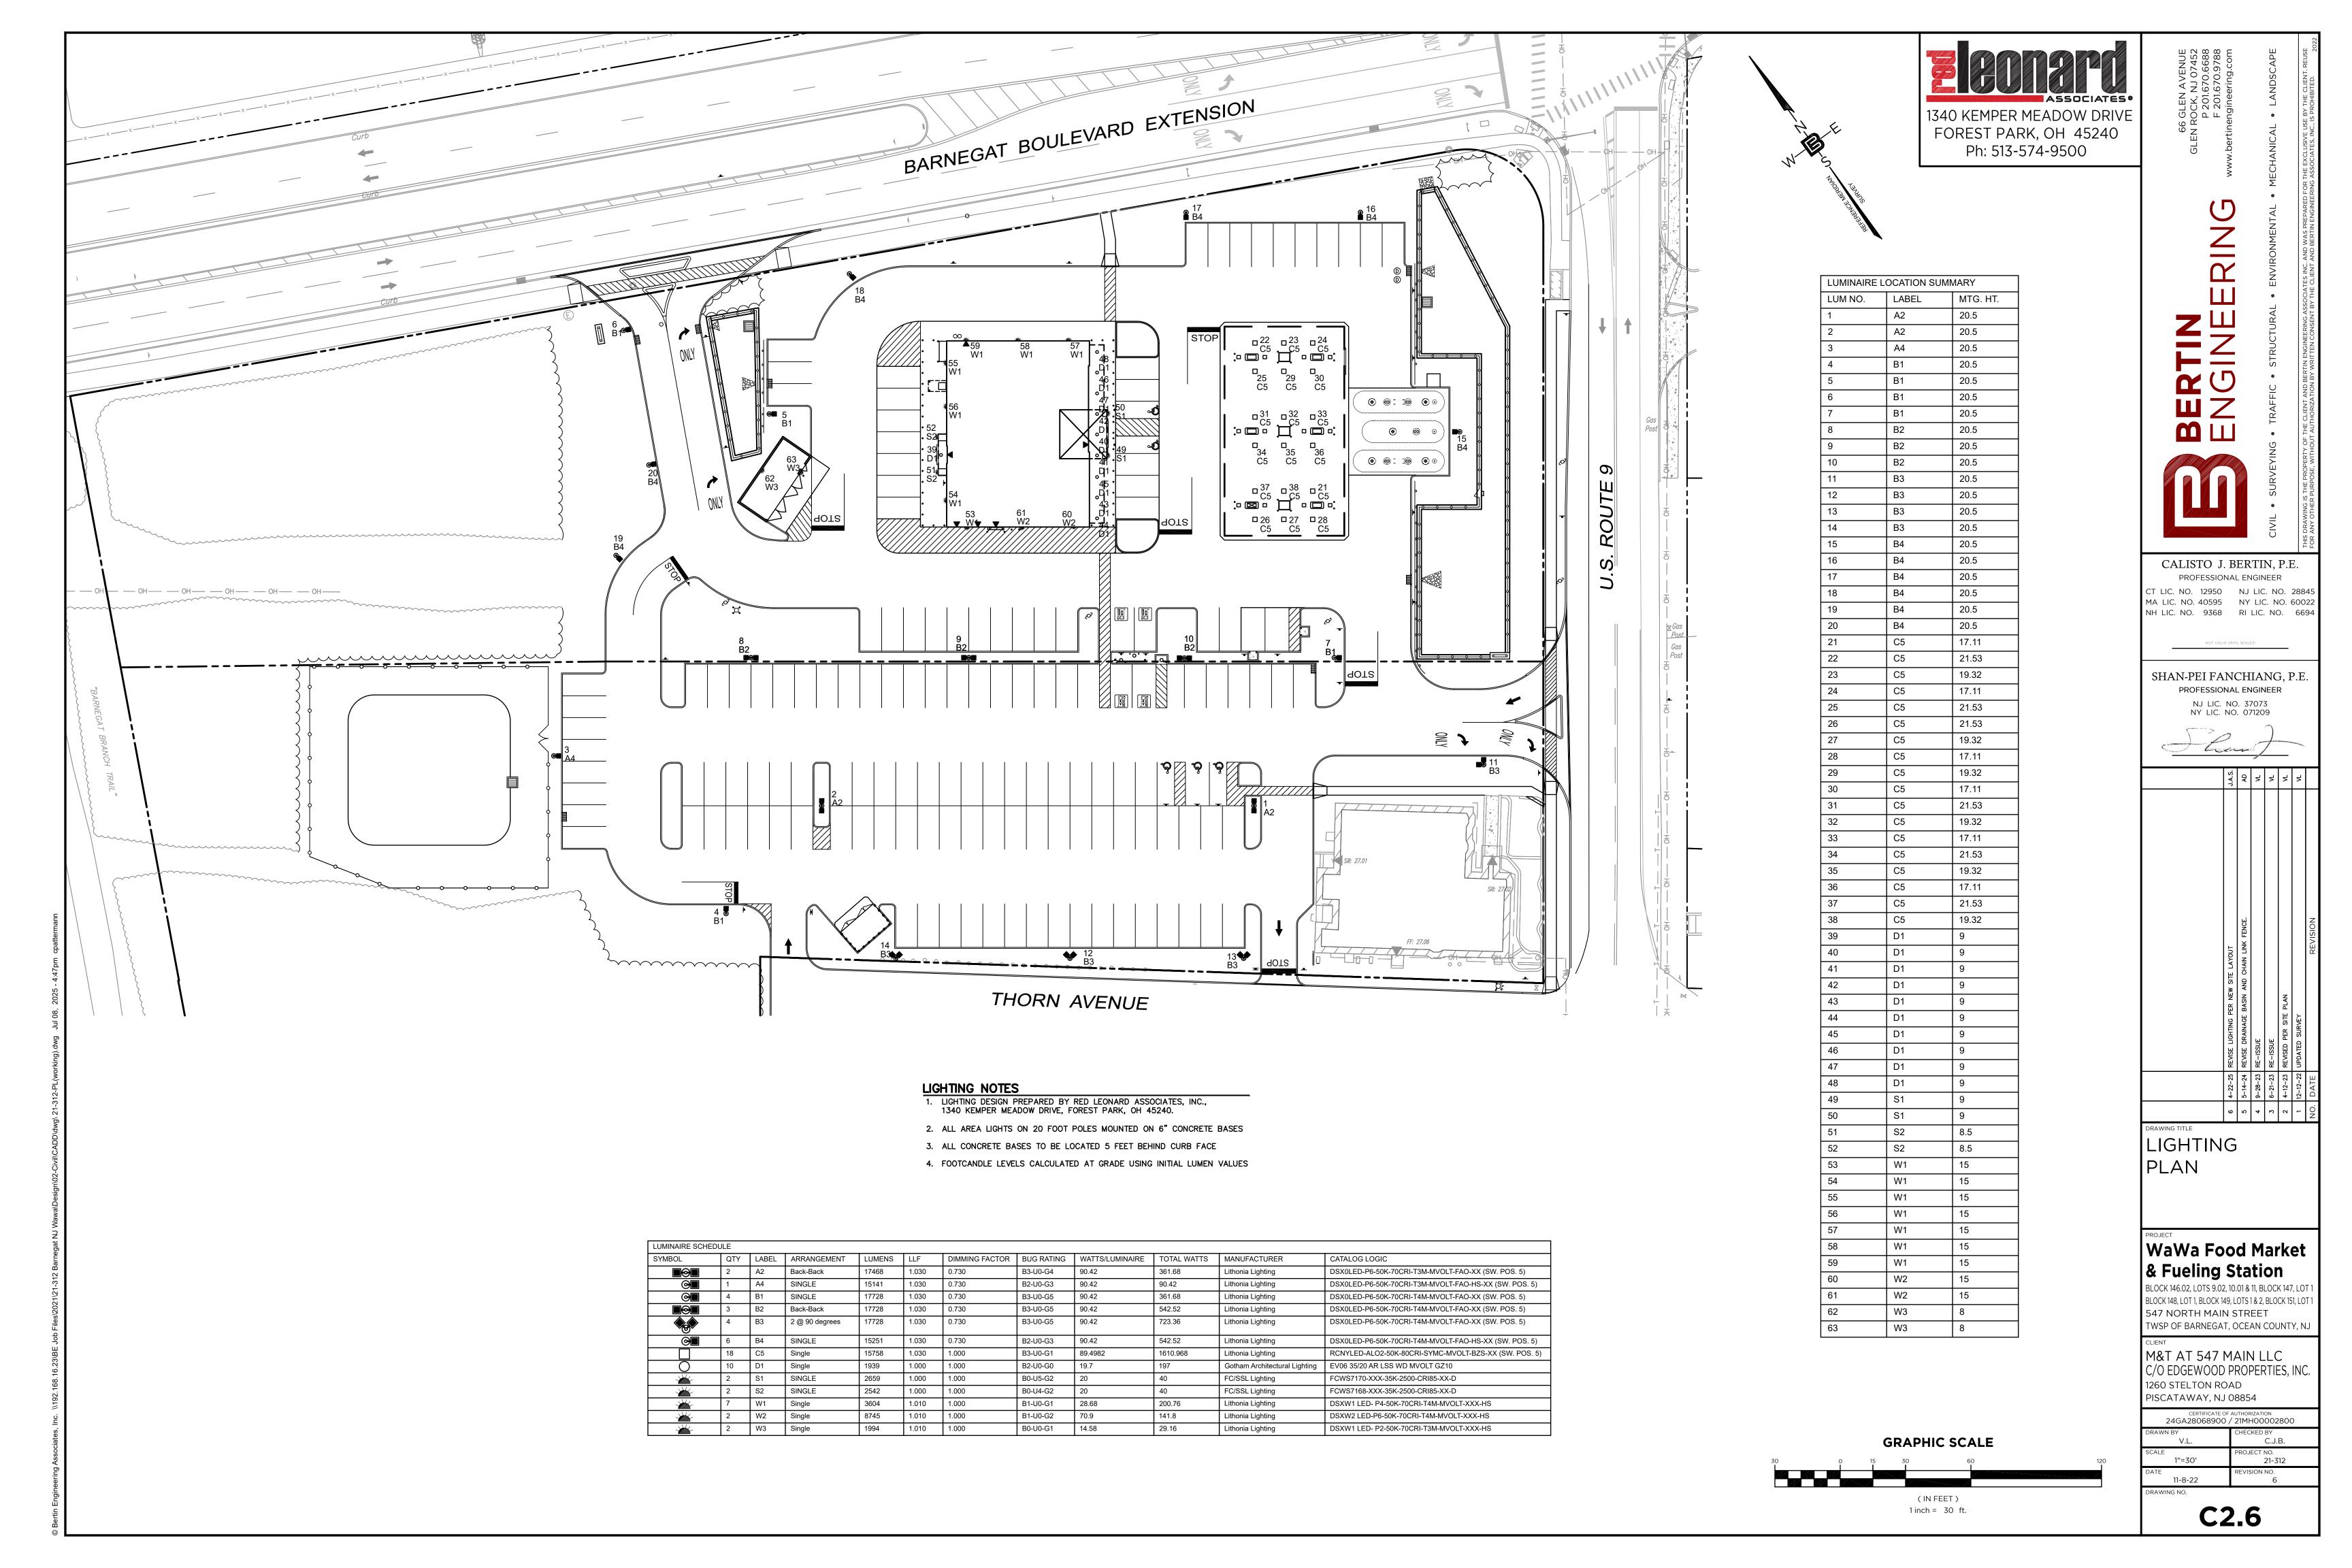

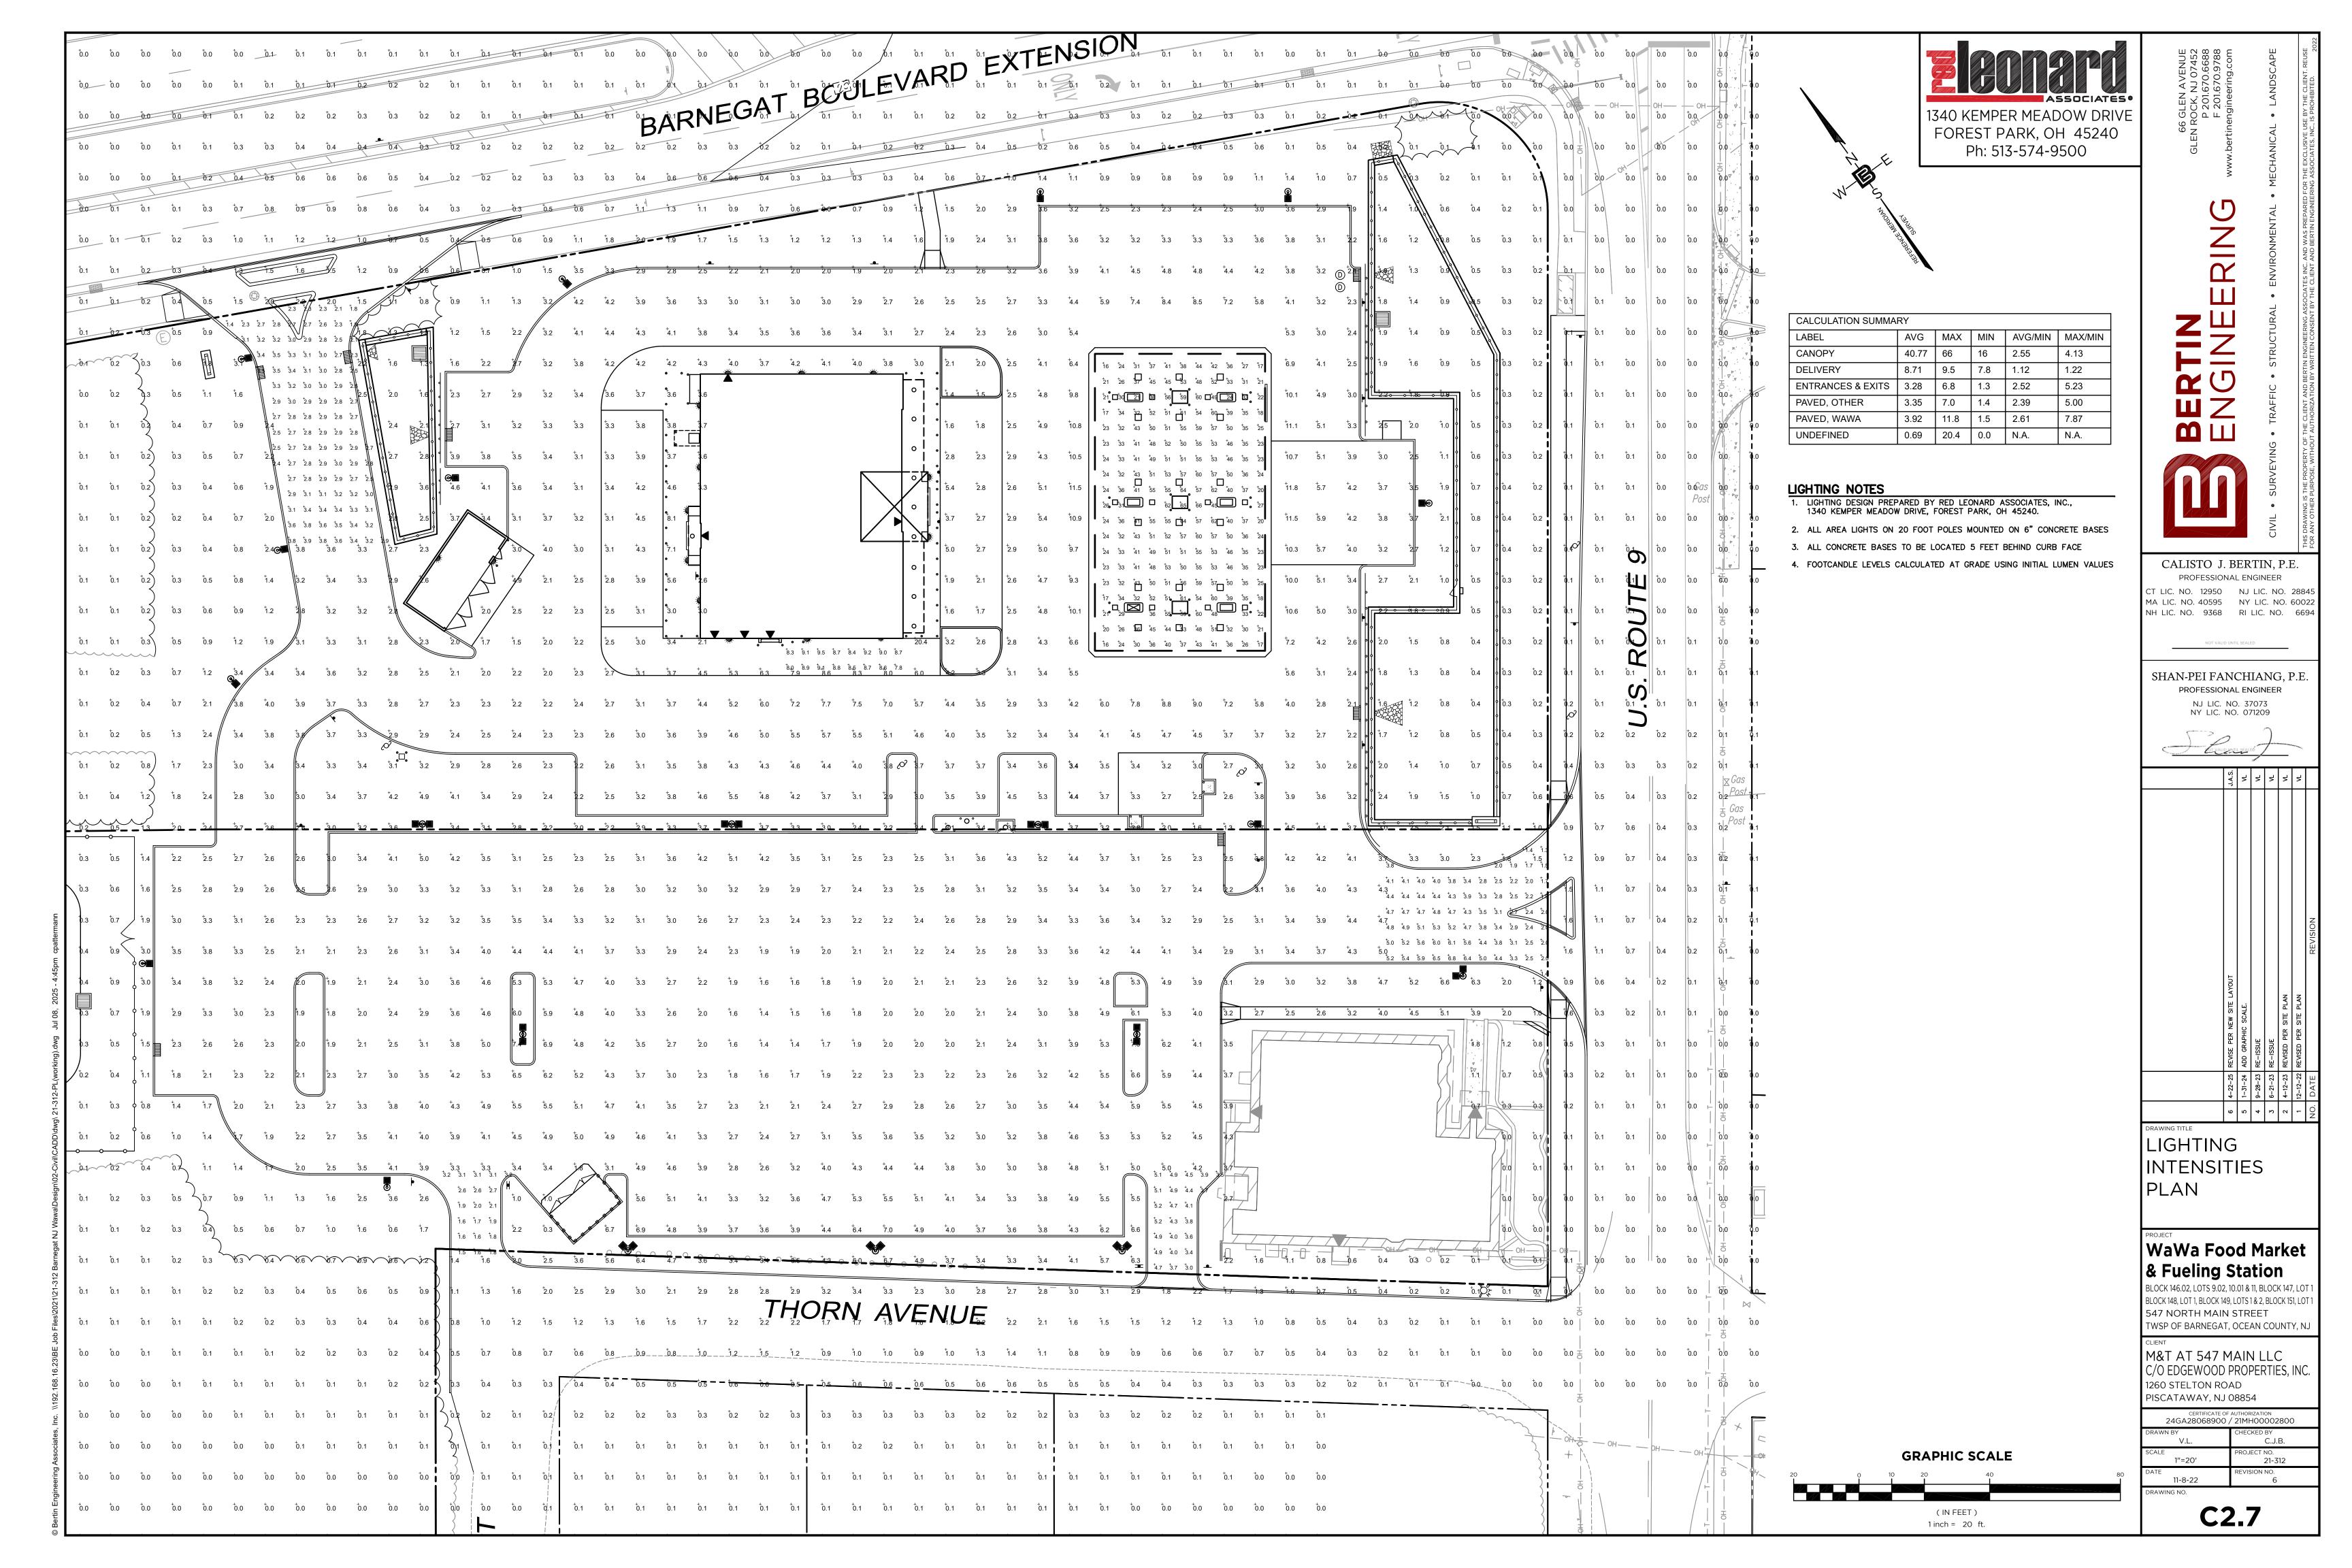


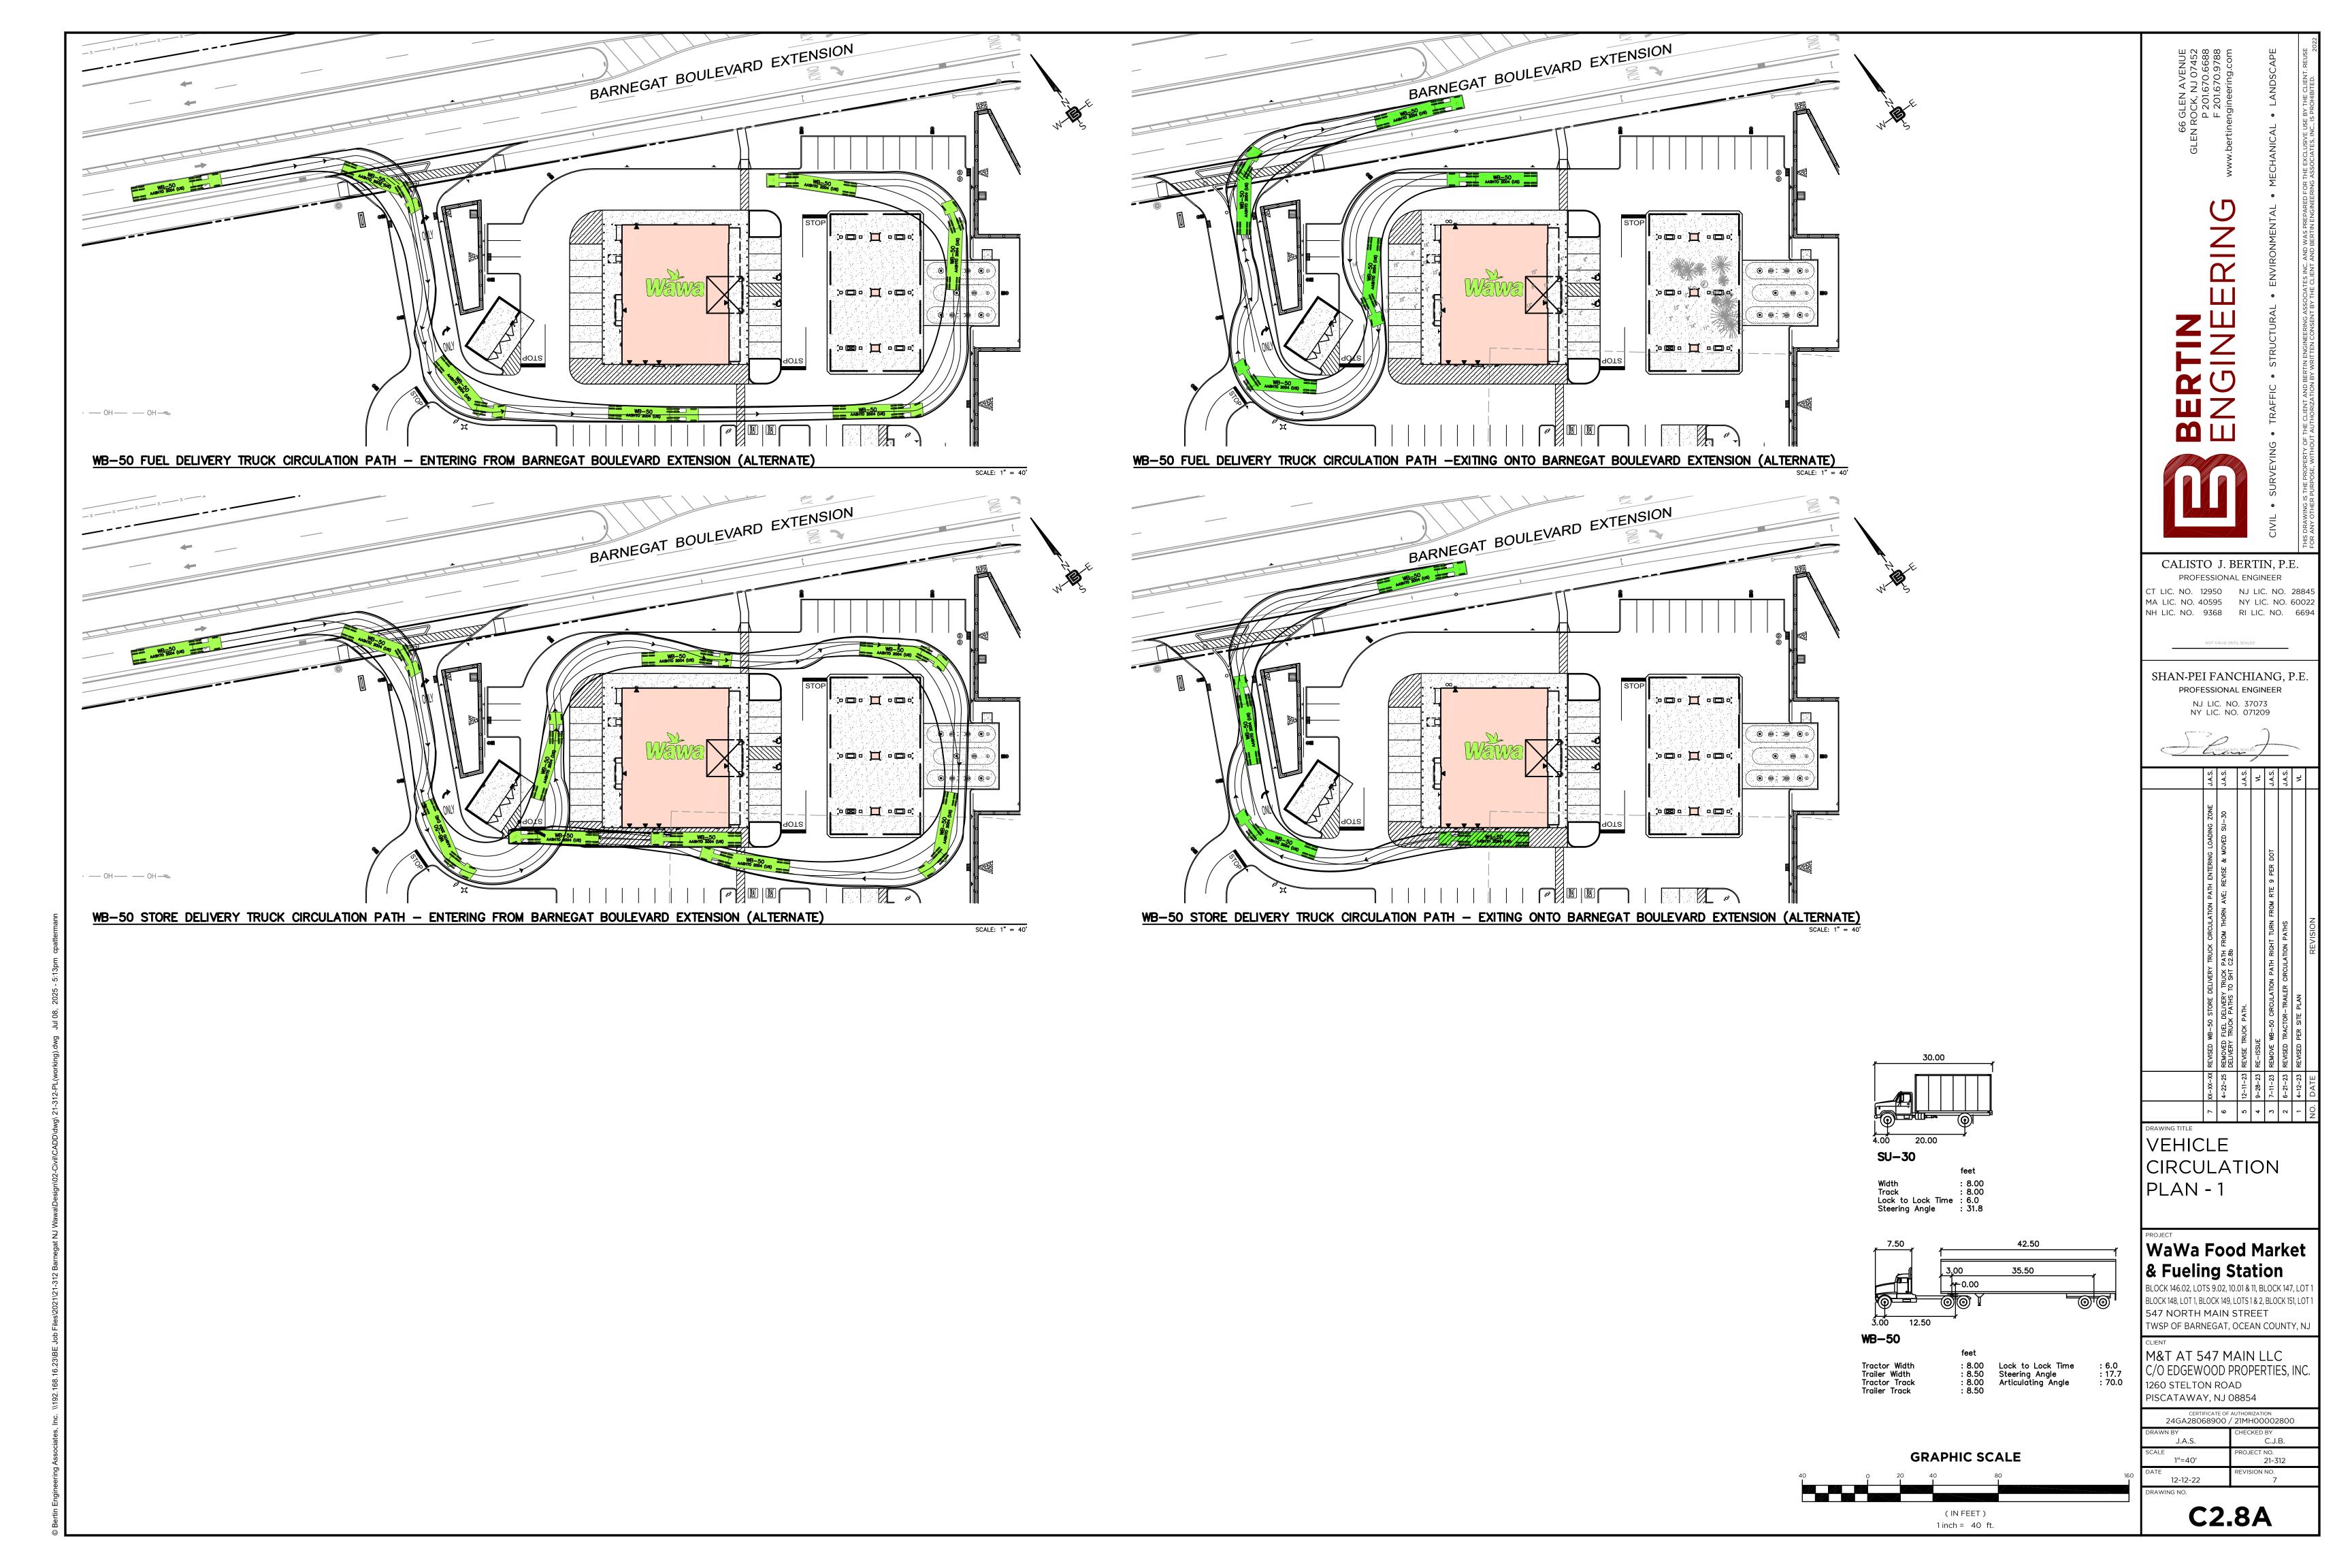


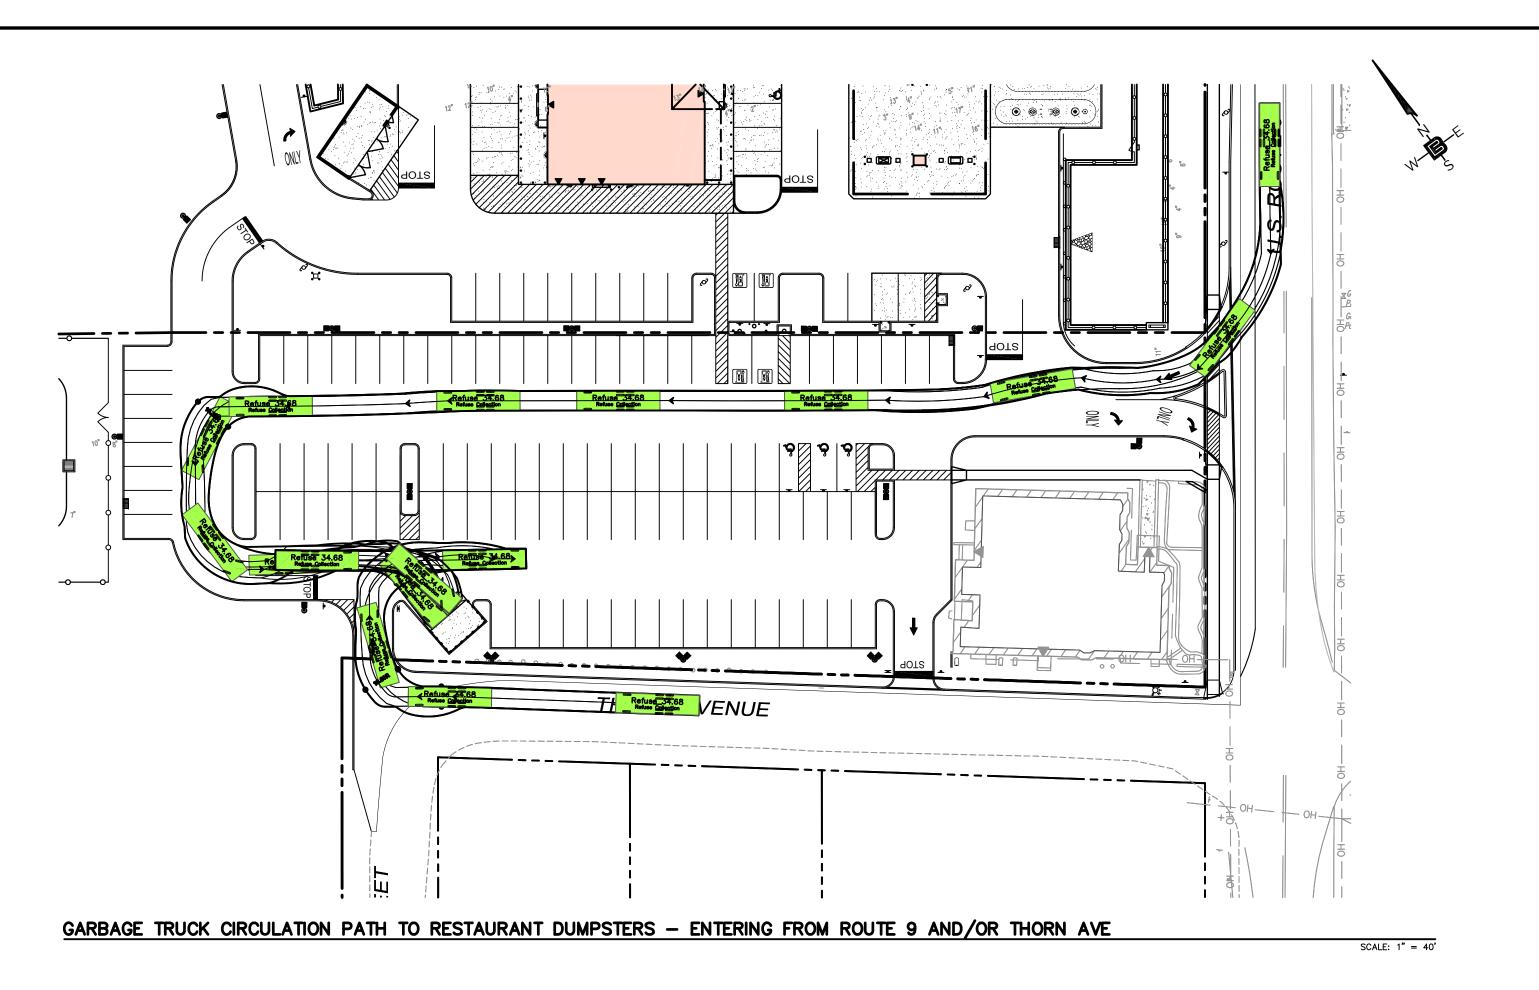


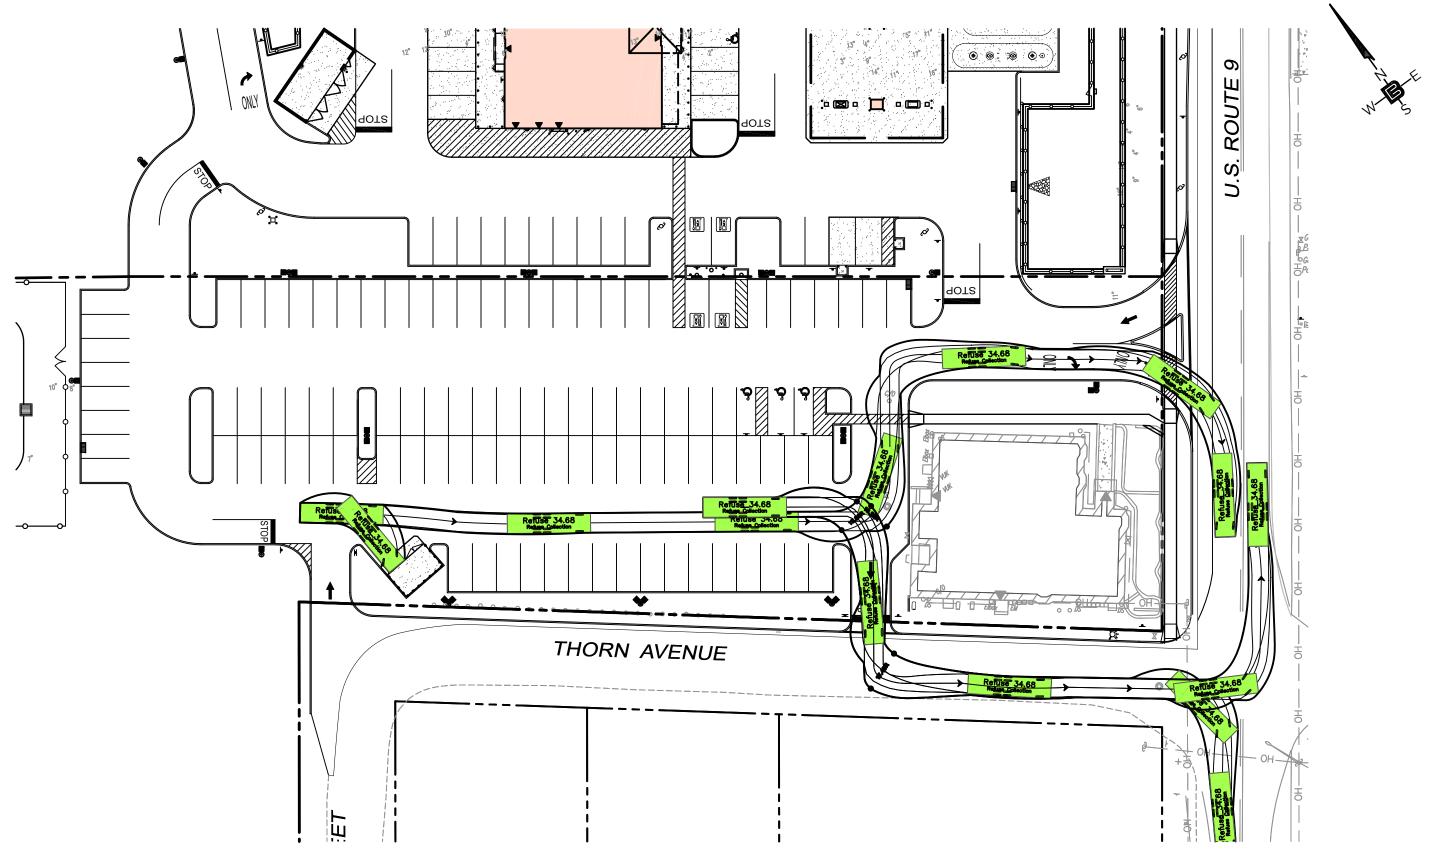

GARBAGE TRUCK CIRCULATION PATH FROM RESTAURANT DUMPSTERS - EXITING ONTO ROUTE 9 AND/OR THORN AVE

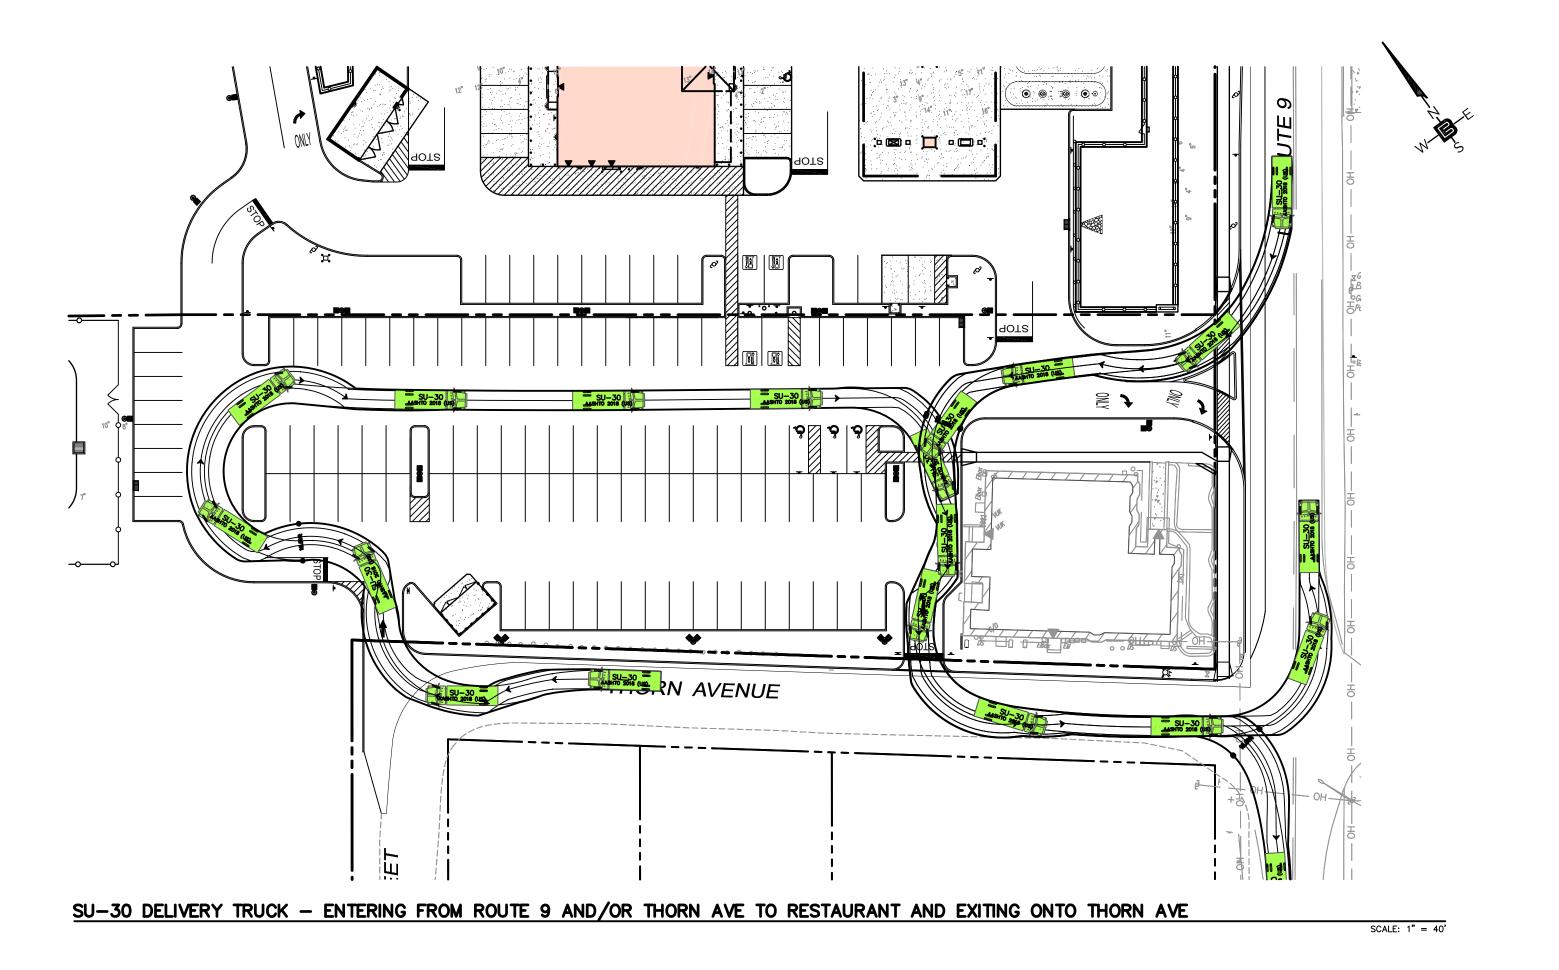

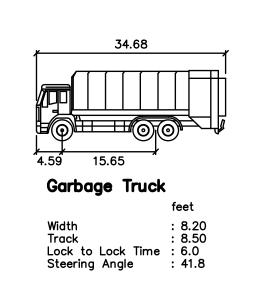

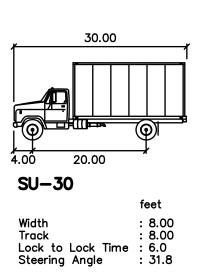

GRAPHIC SCALE

1 inch = 40 ft.

CALISTO J. BERTIN, P.E. PROFESSIONAL ENGINEER MA LIC. NO. 40595 NY LIC. NO. 60022 NH LIC. NO. 9368 RI LIC. NO. 6694 SHAN-PEI FANCHIANG, P.E PROFESSIONAL ENGINEER NJ LIC. NO. 37073 NY LIC. NO. 071209

SCALE: 1" = 40'

VEHICLE CIRCULATION PLAN - 2

WaWa Food Market & Fueling Station

BLOCK 146.02, LOTS 9.02, 10.01 & 11, BLOCK 147, LOT 1
BLOCK 148, LOT 1, BLOCK 149, LOTS 1 & 2, BLOCK 151, LOT 1
547 NORTH MAIN STREET
TWSP OF BARNEGAT, OCEAN COUNTY, NJ

M&T AT 547 MAIN LLC C/O EDGEWOOD PROPERTIES, INC. 1260 STELTON ROAD PISCATAWAY, NJ 08854

CERTIFICATE OF AUTHORIZATION 24GA28068900 / 21MH00002800			
DRAWN BY J.A.S.	CHECKED BY C.J.B.		
SCALE 1"=40'	PROJECT NO. 21-312		
DATE 4-22-25	REVISION NO. O		

C2.8B

